
DEMOLITION PLAN LEGEND DENOTES EXISTING TO REMAIN DENOTES EXISTING TO BE REMOVED

	DEMOLITION KEY NOTES
1	REMOVE EXISTING WHEELCHAIR LIFT AND RELOCATE TO NEW LOCATION AS INDICATED. (REFER TO FLOOR PLAN FOR PROPOSED WORK)
2	REMOVE EXISTING INTERIOR GYPSUM BOARD WALL/SOFFITS TO ACCOMMODATE NEW LAYOUT.
3	REMOVE EXISTING DOOR. (REFER TO FLOOR PLAN FOR PROPOSED WORK)
4	REMOVE EXISTING DRINKING FOUNTAIN AND INSTALL IN NEW LOCATION AS INDICATED. (REFER TO FLOOR PLAN FOR PROPOSED WORK)

DEMOLITION NOTES

- 1. THIS DRAWING IS ONLY TO ASSIST IN SHOWING THE SCOPE OF DEMOLITION WORK AND IS NOT INTENDED TO INDICATE ALL DEMOLITION. CONTRACTOR SHALL REMOVE ALL EXISTING ITEMS AS REQUIRED TO COMPLETE THE JOB.
- NOT ALL ITEMS TO BE DEMOLISHED ARE SHOWN ON THIS PLAN CONTRACTOR SHALL BE RESPONSIBLE FOR PERFORMING A
 WALK-THRU OF THE PROJECT WITH THE INTENT OF IDENTIFYING POSSIBLE ITEMS, NOT OR INCORRECTLY ADDRESSED, WHICH
 REQUIRE REMOVAL AND/OR RELOCATION.
- 3. GENERAL CONTRACTOR SHALL BE RESPONSIBLE FOR SAFETY AND SUPPORT OF STRUCTURE. ASSUME LIABILITY FOR DAMAGE OR INJURY RELATED TO ANY PORTION OF THE WORK.
- CUT, REMOVE, PATCH, ALTER AND RE-FINISH EXISTING CONSTRUCTION AS REQUIRED TO LEAVE WORK COMPLETE AND IN SATISFACTORY CONDITION.
- 5. PROVIDE SAFETY FEATURES DURING WORK AS REQ. BY, APPLICABLE CODES, RULES AND REGULATIONS.
- CONTRACTOR SHALL CEASE OPERATIONS AND NOTIFY THE ARCHITECT/ENGINEER IMMEDIATELY IF SAFETY OF STRUCTURE
 APPEARS TO BE ENDANGERED. TAKE PRECAUTIONS TO PROPERLY SUPPORT STRUCTURE. DO NOT RESUME OPERATION UNTIL
 SAFETY IS RESTORED.
- PATCH AND REPAIR ALL EXISTING SURFACES DAMAGED BY DEMOLITION AND/OR NEW WORK AS REQUIRED TO MATCH ADJACENT SURFACES AND/OR AS REQUIRED FOR NEW SCHEDULED FINISHES.
- 8. CONTRACTOR SHALL PERFORM DEMOLITION IN ACCORDANCE WITH APPLICABLE AUTHORITIES HAVING JURISDICTION.
- 9. REMOVE EXISTING FINISHES AS REQUIRED TO ACCOMMODATE NEW PROPOSED WORK AND REPLACE AS REQUIRED.

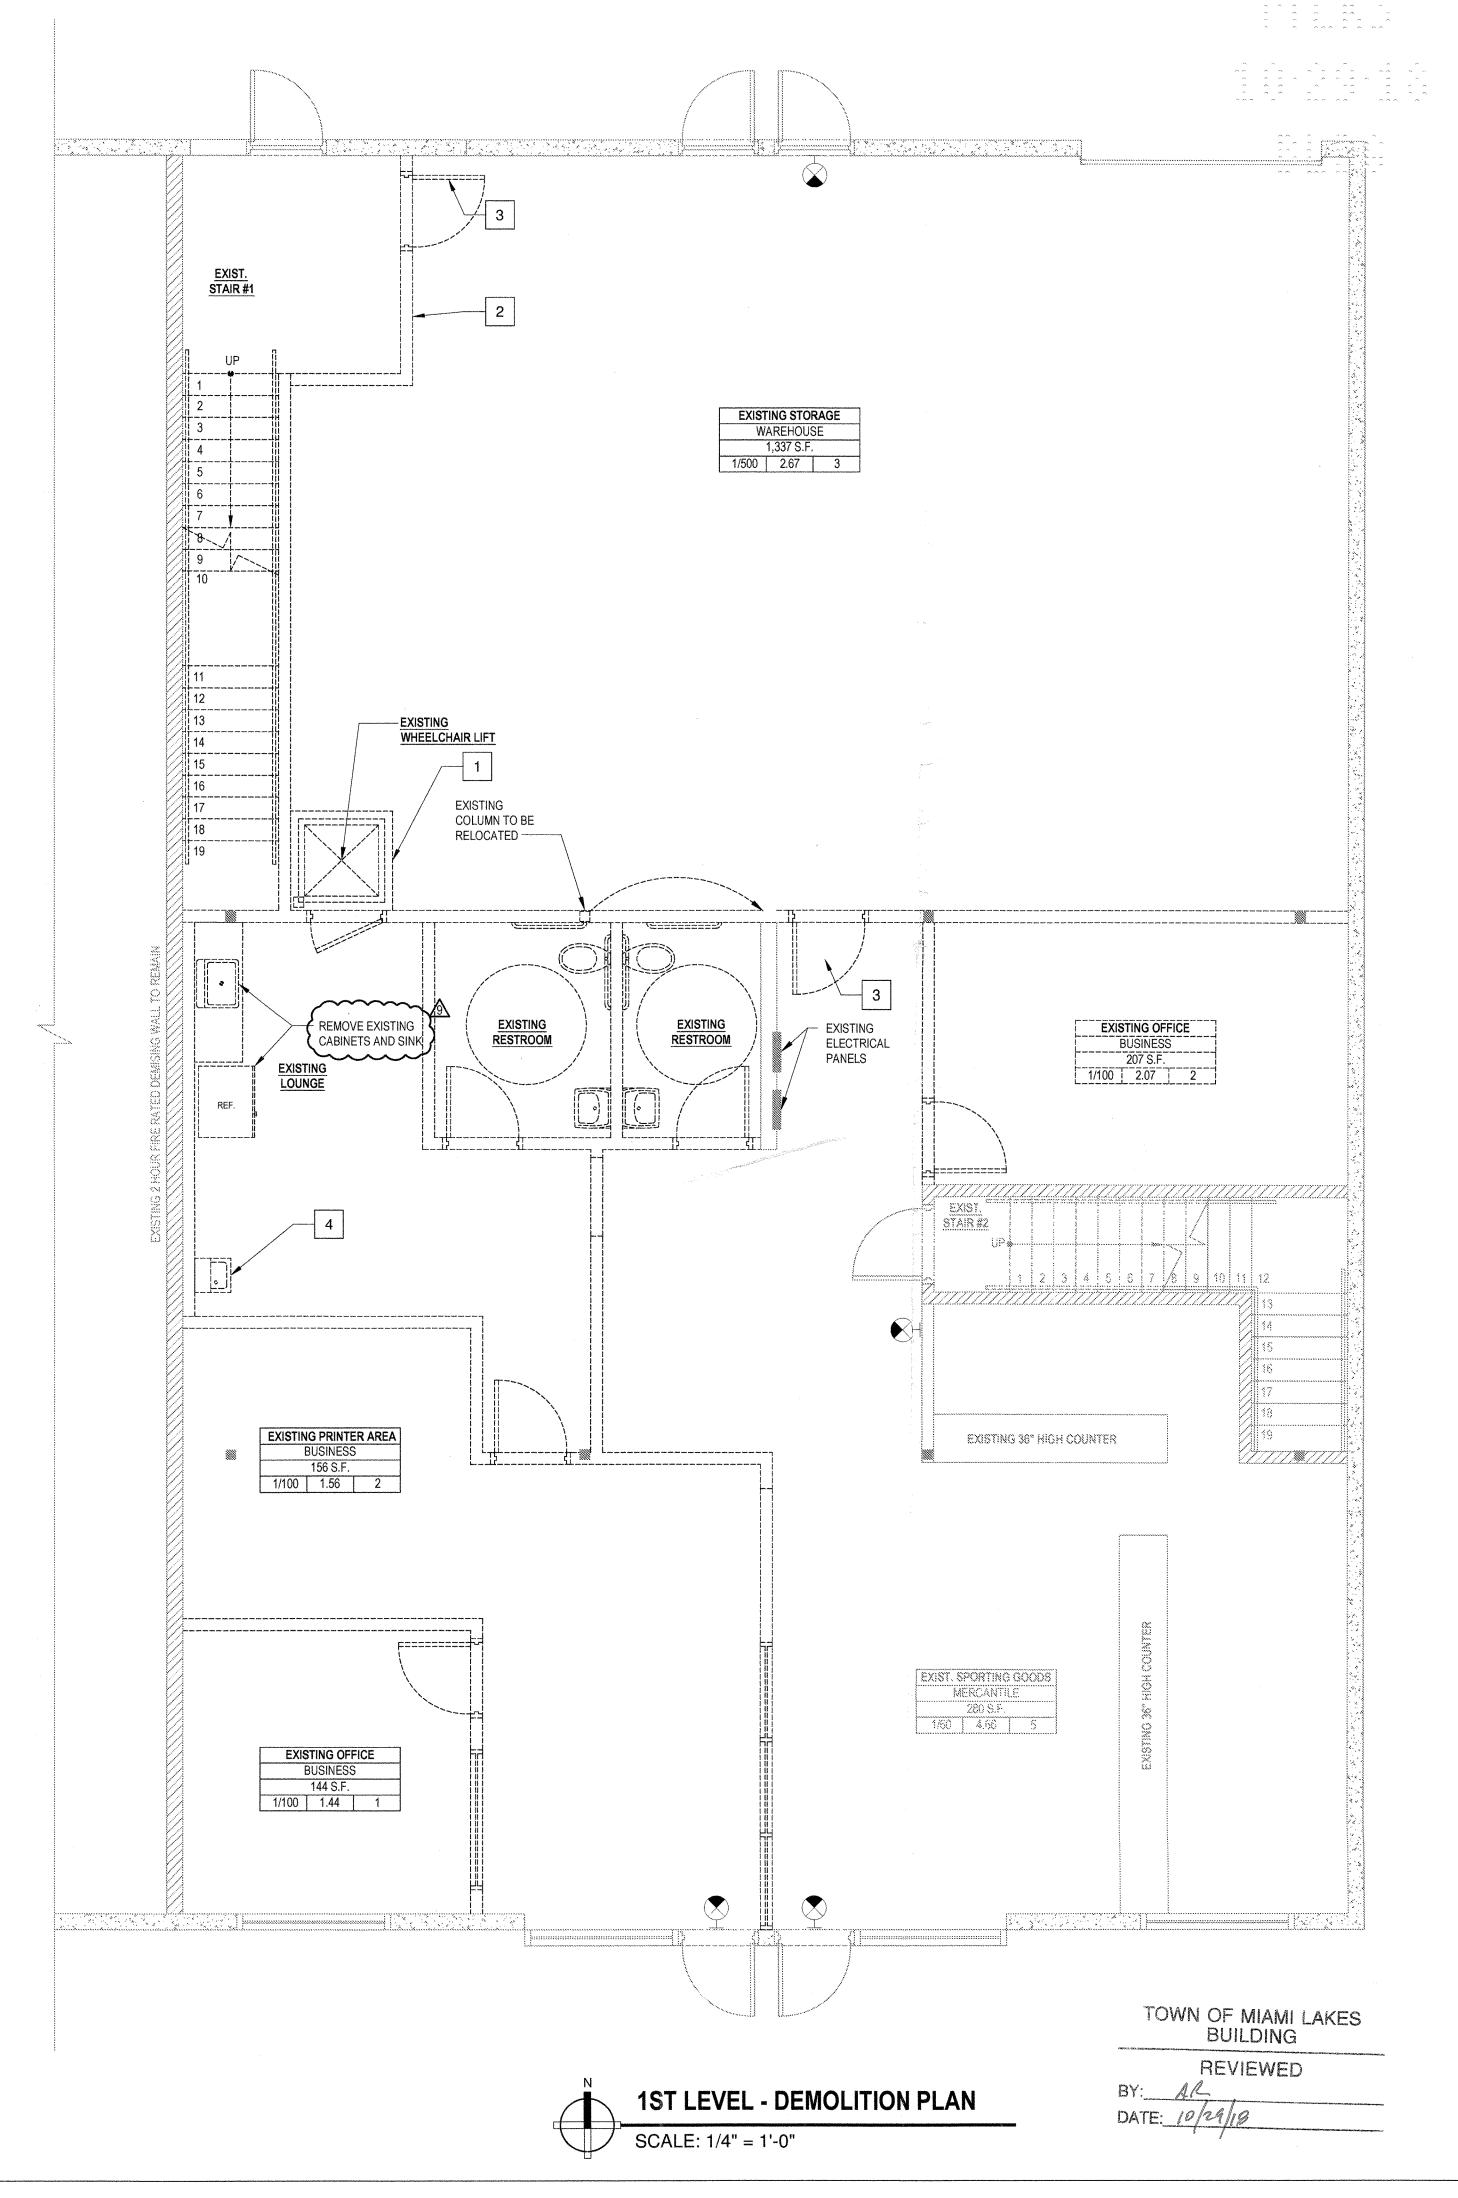





AA 0003470 - IB0001256

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ANDY'S POLICE SUPPLY
RESS: 14000-14002 N.W. 82nd AVE MIAMI LAKES, FLORIDA 3

DANIEL E. DIEZ, R.A.

L	
ISSUES:	DATE:
PERMIT SET	05-31-16
6 OWNER CHANGES	06-23-17
9 OWNER CHANGES	10-23-18

1ST LEVEL
DEMOLITION PLAN

PROJECT NO.

SHEET


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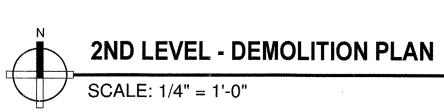
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TOWN OF MIAMI LAKES BUILDING REVIEWED BY: 4R DATE: 10/29/78






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ISSUES:	DATE:
PERMIT SET	05-31-16
⚠OWNER CHANGES	06-23-17
∕ § OWNER CHANGES	04-13-18
<u>∕</u>	10-23-18
:	

DRAWING TITLE **2ND LEVEL DEMOLITION PLAN**

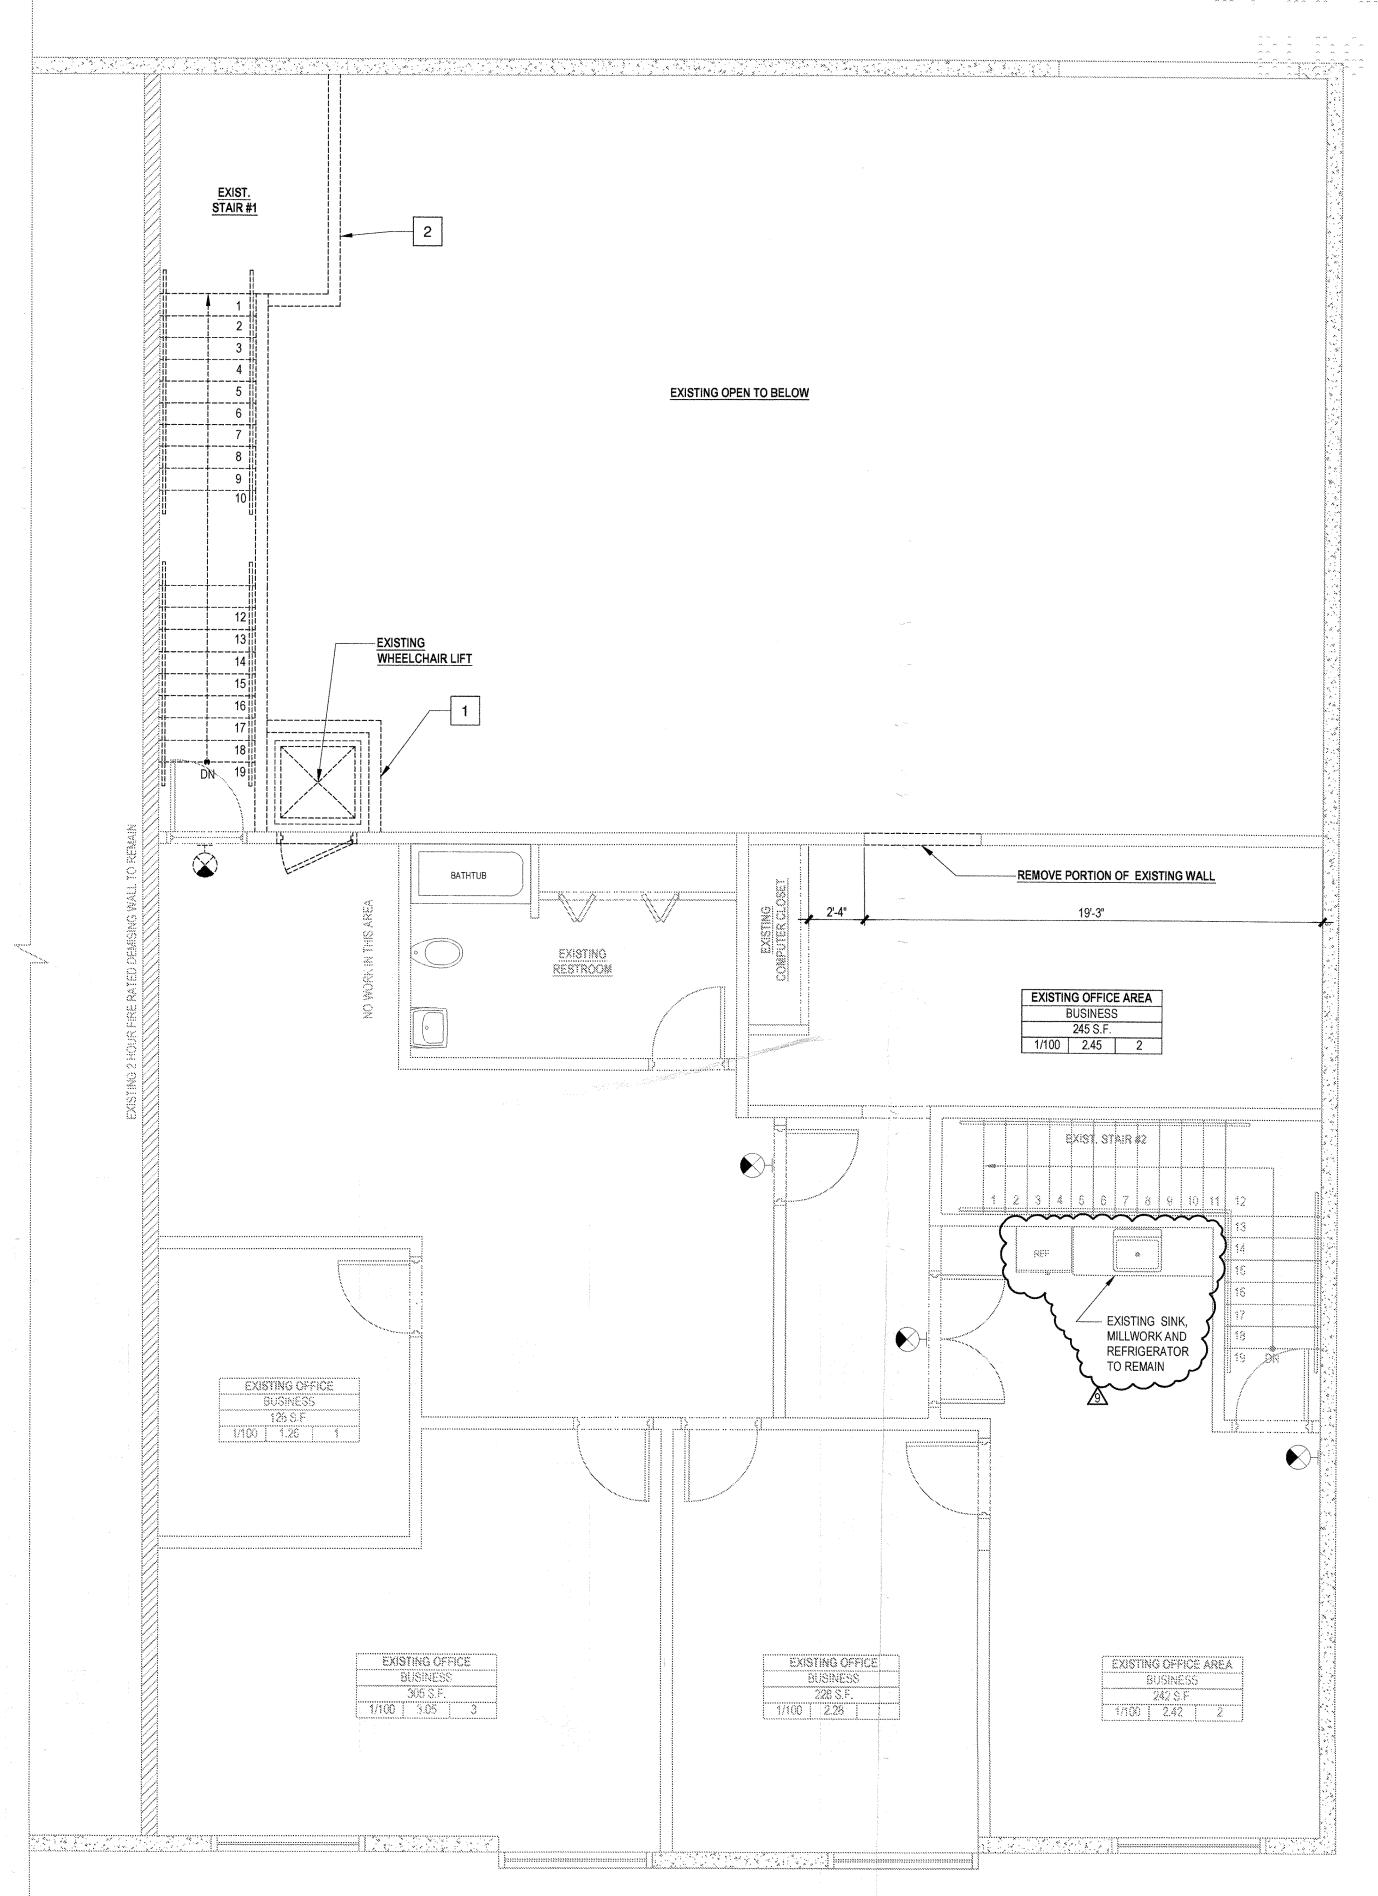PROJECT NO.

SHEET

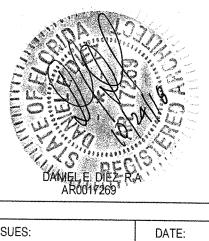A-2

PROJECT INFORMATION

LEGAL DESCRIPTION:

TRACT "F", "MIAMI LAKES BUSINESS PARK SECTION TWO", LESS THE NORTH 181.50 FEET THEREOF, ACCORDIN TO TH PLAT THEREOF, AS RECORDED IN PLAT BOOK 156 AT PAGE 68 OF THE PUBLIC RECORDS OF MIAMI-DADE COUNTY, FLORIDA, LYING AND BEING SECTION 22, TOWNSHIP 52 SOUTH, RANGE 40 EAST, CITY OF MIAMI LAKE MIAMI-DADE COUNTY, FLORIDA.

PROJECT ADDRESS:

14000-14002 N.W. 82 AVE. MIAMI LAKES, FL 33015 (UNITS 23 AND 24)

FOLIO NO.: 32-2022-052-0240

ZONING GENERAL INFORMATION:

ZONING: IU-2 (INDUSTRIAL)

BUILDING INFORMATION:

CONSTRUCTION TYPE:

BUSINESS / MERCANTILE / INDUSTRIAL / STORAGE

OCCUPANCY CLASSIFICATION: (MIXED OCCUPANCY)

FLOOR PLAN LEGEND DENOTES EXISTING TO REMAIN DENOTES EXISTING CONCRETE TILT UP PANEL DENOTES EXISTING 2HR FIRE RATED GWB WALL DENOTES NEW STUD WALL CONSTRUCTION DENOTES NEW SOUND PROOF STUD WALL CONSTRUCTION DENOTES WALL TAG (REFER TO PARTITIONS DETAILS, PARTITION NOTES AND INTERIOR STUD FRAMING LIMITATIONS CHART) DENOTES EXISTING EXIT SIGN DENOTES EGRESS PATH / TRAVEL DISTANCE / COMMON PATH 4000 6000 1000 1000 6000 1000 5000 6000 1000 6000 **ROOM TAG** ROOM NAME ROOM NAME OCCUPANCY TYPE OCCUPANCY TYPE FLOOR AREA S.F. - FLOOR AREA 1/X #

GENERAL NOTES

ACTUAL OCCUPANT LOAD

OCCUPANT LOAD FACTOR

- MAX. OCCUPANT LOAD

- THE CONTRACTOR IS TO VISIT THE SITE AND VERIFY ALL EXISTING BUILDING AND SITE CONDITIONS PRIOR TO SUBMITTING HIS PROPOSAL FOR THE WORK. SHOULD ANY DISCREPANCIES BE ENCOUNTERED, THE ARCHITECT SHOULD BE NOTIFIED IN WRITING 7 DAYS PRIOR TO SUBMITTING HIS BID.
- ALL WORK DONE UNDER THE SUPERVISION OF THE CONTRACTOR SHALL BE IN A NEAT AND WORKMAN-LIKE MANNER AND IN ACCORDANCE WITH ALL GOVERNING AGENCIES, RULES AND REGULATIONS HAVING
- THE CONTRACTOR IS TO PROVIDE ALL THE SUPPLEMENTARY MATERIALS REQUIRED TO PROPERLY INSTAL SUPPORT, BRACE AND SHORE ALL BUILDING COMPONENTS WITHIN THE SCOPE OF THE PROJECT.
- THE CONTRACTOR IS TO PREPARE THE JOB SITE PARTITION LAYOUT FOR REVIEW OF THE ARCHITECT PRIOR TO ERECTING PARTITIONS, THE WORDING "ALIGN" DENOTES GYPSUM BOARD SHEETING OVER FACE OF BASE BUILDING COLUMNS AND WALL SURFACES AT JUNCTION WITH INTERIOR PARTITION TO ALIGN THE TWO DISSIMILAR PARTS AND PROVIDE A SMOOTH CRACK FREE SURFACE (TYPICAL ALL CONDITIONS).
- WHERE DISSIMILAR METALS COME IN CONTACT, CONTRACTOR IS TO PREVENT VIBRATIONS AND NOISE
- TRANSMISSION BETWEEN THE METALS AND ELECTROLYTIC ACTION. PROVIDE DOUBLE STUDS AT ALL DOOR JAMBS.
- 7. ALL GYPSUM BOARD SHEATHING SHALL BE 1/2" THICKNESS (UNLESS OTHERWISE NOTED)
- 8. ALL APPLICABLE RECOGNIZED NATIONAL CONSTRUCTION INDUSTRY STANDARDS FOR MATERIALS AND INSTALLATION SHALL BE A FULL PART OF THESE CONTRACT DOCUMENTS.
- ON-SITE VERIFICATION OF ALL DIMENSIONS AND CONDITIONS SHALL BE THE RESPONSIBILITY OF THE CONTRACTOR, NOTED DIMENSIONS TAKE PRECEDENCE OVER SCALE. ANY DISCREPANCIES SHALL BE REPORTED TO THE ARCHITECT AT ONCE BEFORE PROCEEDING.
- 10. ALL WORK TO BE IN ACCORDANCE WITH THE FLORIDA BUILDING CODE AND DADE COUNTY ORDINANCES. 11. ALL CONTRACTORS SHALL BE RESPONSIBLE FOR PROPER DISPOSAL OF WASTE MATERIALS DUE TO THEIR
- RESPECTIVE ACTIVITIES.
- 12. PRESSURE TREAT ALL LUMBER IN CONTACT WITH MASONRY OR CONCRETE.
- 13. ALL ROOF SHEATHING SHALL BE 5 / 8" (MIN.) EXT. GRADE PLYWOOD NAILED TO WOOD RAFTERS @ 16" c / c W / 8d GALV. NAILS, @ 6" c / c ALL SUPPORTS AND 4" c / c PANEL EDGES
- 14. DIMENSIONS AS INDICATED ON THE DRAWINGS SHALL TAKE PRECEDENCE OVER SCALING OF THE DRAWINGS, THE DIMENSIONS INDICATED ON THE DRAWINGS ARE CALCULATED BY COMPUTER AND ARE ROUNDED TO THE NEAREST INCH. THE LOCATION OF PARTITIONS TO ALIGN WITH EXISTING WALLS SHALL TAKE PRECEDENCE OVER WRITTEN DIMENSIONS WHEN SO NOTED. ALL DIMENSIONS SHALL BE FIELD VERIFIED. CONTRACTOR SHALL NOTIFY THE ARCHITECT OF ANY DIMENSIONS THAT ARE IN CONFLICT WITH THE CONSTRUCTION DOCUMENTS.
- 15. NO ELECTRICAL, MECHANICAL, OR PLUMBING EQUIPMENT SHALL BE INSTALLED BELOW BASE FLOOD ELEVATION HEIGHT.
- 16. IN OUTSIDE WINDOWS OR DOORS OPERABLE FROM THE INSIDE, THE MODE OF OPERATION SHALL NOT REQUIRE THE USE OF A KEY, TOOL, SPECIAL KNOWLEDGE OR EFFORT.
- 17. LOT WILL BE GRADED SO AS TO PREVENT DIRECT OVERLAND DISCHARGE OR STORM WATER ONTO ADJACENT PROPERTY.
- 18. ALL WOOD TRUSSES SHALL BE ANCHORED AT BOTH ENDS, WITH APPROVED GALVANIZED METAL TRUSS STRAPS. (SEE FRAMING PLAN, SCHEDULE AND DETAILS)
- 19 SECONDARY MEANS OF ESCAPE SHALL BE PROVIDED FOR EACH BEDROOM, WINDOWS USED AS SECONDARY MEANS OF EGRESS SHALL PROVIDE CLEAR MIN.OPENING 34.2" WIDTH x24" HEIGHT (5.7 sf) AND THE BOTTOM OF THE OPENING SHALL BE NO MORE THAN 44" ABOVE THE FLOOR.
- 20. FIRESTOPPING SHALL BE PROVIDED IN CONCEALED SPACES OF STUDS WALLS AND PARTITIONS INCLUDING FURRED SPACES AT CEILING AND FLOOR LEVELS TO LIMIT THE MAXIMUM DIMENSION TO 8FT.

INTERIOR FINISHES NOTE:

ALL INTERIOR FINISHES FLAME SPREAD INDEX SHALL COMPLY WITH THE REQUIREMENTS FOR GROUP S. AS PER TABLE 803.9 OF 2014 FBC AND SHALL BE AS FOLLOWS: - EXIT ENCLOSURES AND EXIT PASSAGEWAYS = CLASS B

- CORRIDORS = CLASS B - ROOMS AND ENCLOSED SPACES = CLASS C

SCOPE OF WORK

FLORIDA BUILDING CODE CLASSIFICATION OF WORK: ALTERATION - LEVEL 2

NFPA 101, CHAPTER 43 CLASSIFICATION OF REHABILITATION: RECONSTRUCTION

NEW SHOOTING RANGE, NEW RESTROOMS, RELOCATED STAIR, RELOCATED ELEVATOR, NEW LIGHT STORAGE.

NEW PLUMBING WORK AS INDICATED. REFERE TO PLUMBING DRAWINGS.

NEW MECHANICAL WORK AS INDICATED. REFER TO MECHANICAL DRAWINGS.

NEW ELECTRICAL WORK AS INDICATED. REFER TO ELECTRICAL DRAWINGS.

2ND LEVEL

OFFICE AREAS

STORAGE AREA

2ND LEVEL = 13

MODIFICATIONS TO EXISTING SYSTEM AS INDICATED. REFER TO FIRE SPRINKLER DRAWINGS.

OCCUPANT LOAD AND EXIT CAPACITY

(AS PER 2014 FLORIDA BUILDING CODE, CHAPTER 10, TABLE 1004.1.2)

SPACE NAME	FUNCTION OF SPACE	TOTAL OCCUPANTS	
1ST LEVEL			
SPORTING GOODS AREA	MERCANTILE	5	
OPEN OFFICE AREA	BUSINESS	3	
WAREHOUSE/STORAGE AREA	WAREHOUSE	1	
CHECK-IN AREA	BUSINESS	1	
SHOOTIN RANGE STAGING AREA	STANDING SPACE	20	
SHOOTING RANGE		0	
		30	

BUSINESS

WAREHOUSE

TOTAL OCCUPANCY = 43

11

TOTAL EXIT CAPACITY (SEE FLOOR PLAN) = 510

PLUMBING FIXTURES CALCULATIONS (AS PER 2014 FLORIDA PLUMBING CODE, TABLE 403.1) MINIMUM REQUIRED PROVIDED **TOTAL MAXIMUM** WATER LAVATORIES LAVATORIES CLOSETS **CLOSETS** OCCUPANTS MALE | FEMALE | MALE | FEMALE MALE FEMALE MALE MALE FEMAL PER 25 FOR THE FIRST 50 AND PER 40 FOR THE FIRST 80 AND 1 PER 50 FOR THE REMAINDER 1 PER 80 FOR THE REMAINDER 1ST LEVEL = 30 EXCEEDING 50 EXCEEDING 80 PER 40 FOR THE FIRST 80 AN

EXISTING OCCUPANCY PLUS PROPOSED OCCUPANCY COUNT CAN BE HANDLED BY **EXISTING AND NEW PLUMBING FACILITIES.**

PER 80 FOR THE REMAINDER

	DOOR SCHEDULE									
	SIZE									
No.	WIDTH	HEIGHT	IYPE	MATERIAL	FRAME	THRES. HDW.	REMARKS			
(1)	3'-0"	7'-0"	Α	MTL.	MTL.	MTL.	HW-1	BULLETPROOF		
2	3'-0"	7'-0"	Α	MTL.	MTL.	MTL.	HW-1			
3	(2)3'-0"	7'-0"	В	ALUM/GLASS	ALUM.	ALUM.	HW-2			
4	3'-0"	7'-0"	Α	MTL.	MTL.	MTL.	HW-1			
(5)	3'-0"	7'-0"	Α	MTL.	MTL.	MTL.	HW-1			
6	2'-8"	7'-0"	С	WOOD	-	-	HW-4	LOUVERED		
7	2'-8"	7'-0"	С	WOOD	-	-	HW-4	LOUVERED		
8	3'-0"	7'-0"	Α	MTL.	MTL.	MTL.	HW-3	FIRE RATED (90 MIN.)		
9	3'-0"	7'-0"	Α	MTL.	MTL.	MTL.	HW-3	FIRE RATED (90 MIN.)		
10	3'-0"	7'-0"	Α	MTL.	MTL.	MTL.	HW-3	FIRE RATED (90 MIN.)		
(11)	3'-0"	7'-0"	А	MTL.	MTL.	MTL.	HW-3	FIRE RATED (90 MIN.)		
(12)	3'-0"	7'-0"	Α	MTL.	MîL.	MTL.	HW-1	:.		
13	3'-0"	7'-0"	Α	MTL.	MTL.	MTL.	HW-1			
(14)	5'-0"	7'-0"	С	WOOD	WOOD	-	HW-4	LOUVERED		

DOOR NOTES:

VERIFY ROUGH OPENING SIZES WITH DOOR MANUFACTURER PRIOR TO INSTALLATION.

PER 50 FOR THE REMAINDER

EXCEEDING 50


ALL DOOR HANDLES TO BE LEVER TYPE PER STATE AND LOCAL ACCESSIBILITY REQUIREMENTS. EXIT DOORS SHALL BE


WHEN APPLICABLE CONTRACTOR TO PROVIDE PRODUCT CONTROL APPROVAL FOR ALL EXTERIOR DOOR OR WINDOWS.

OPERABLE FROM THE INSIDE WITHOUT THE USE OF A KEY OR ANY SPECIAL KNOWLEDGE. PROVIDE DOOR STOPS ON ALL DOORS - ROCKWOOD # 441 US 26 OR EQUAL. (NOTE: PROVIDE FLOOR STOPS WHERE POSSIBLE.)

HARDWARE SCHEDULE:

- HW-1 1-1/2 PR. BUTTS PROVIDED BY PRE-HUNG DOOR MANUFACTURER
- 1 EA. LOCKSET, LEVER TYPE TO BE SELECTED BY OWNER 1 EA. CLOSER - LCN 1461 OR EQUAL
- HW-2 1 EA. LOCKSET, AS PER DOOR MANUFACTURER TO BE SELECTED BY OWNER HW-3 1-1/2 PR. BUTTS - PROVIDED BY PRE-HUNG DOOR MANUFACTURER
- 1 EA. PASSAGE SET, LEVER TYPE TO BE SELECTED BY OWNER
- 1 EA. CLOSER LCN 1461 OR EQUAL HW-4 AS PER DOOR MANUFACTURER - TO BE SELECTED BY OWNER

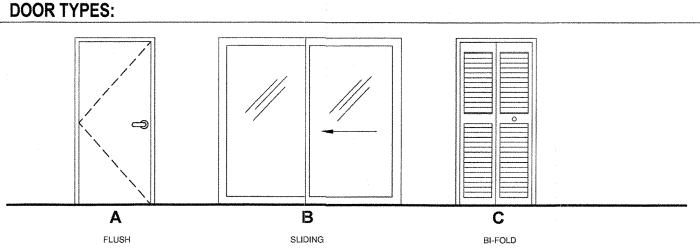

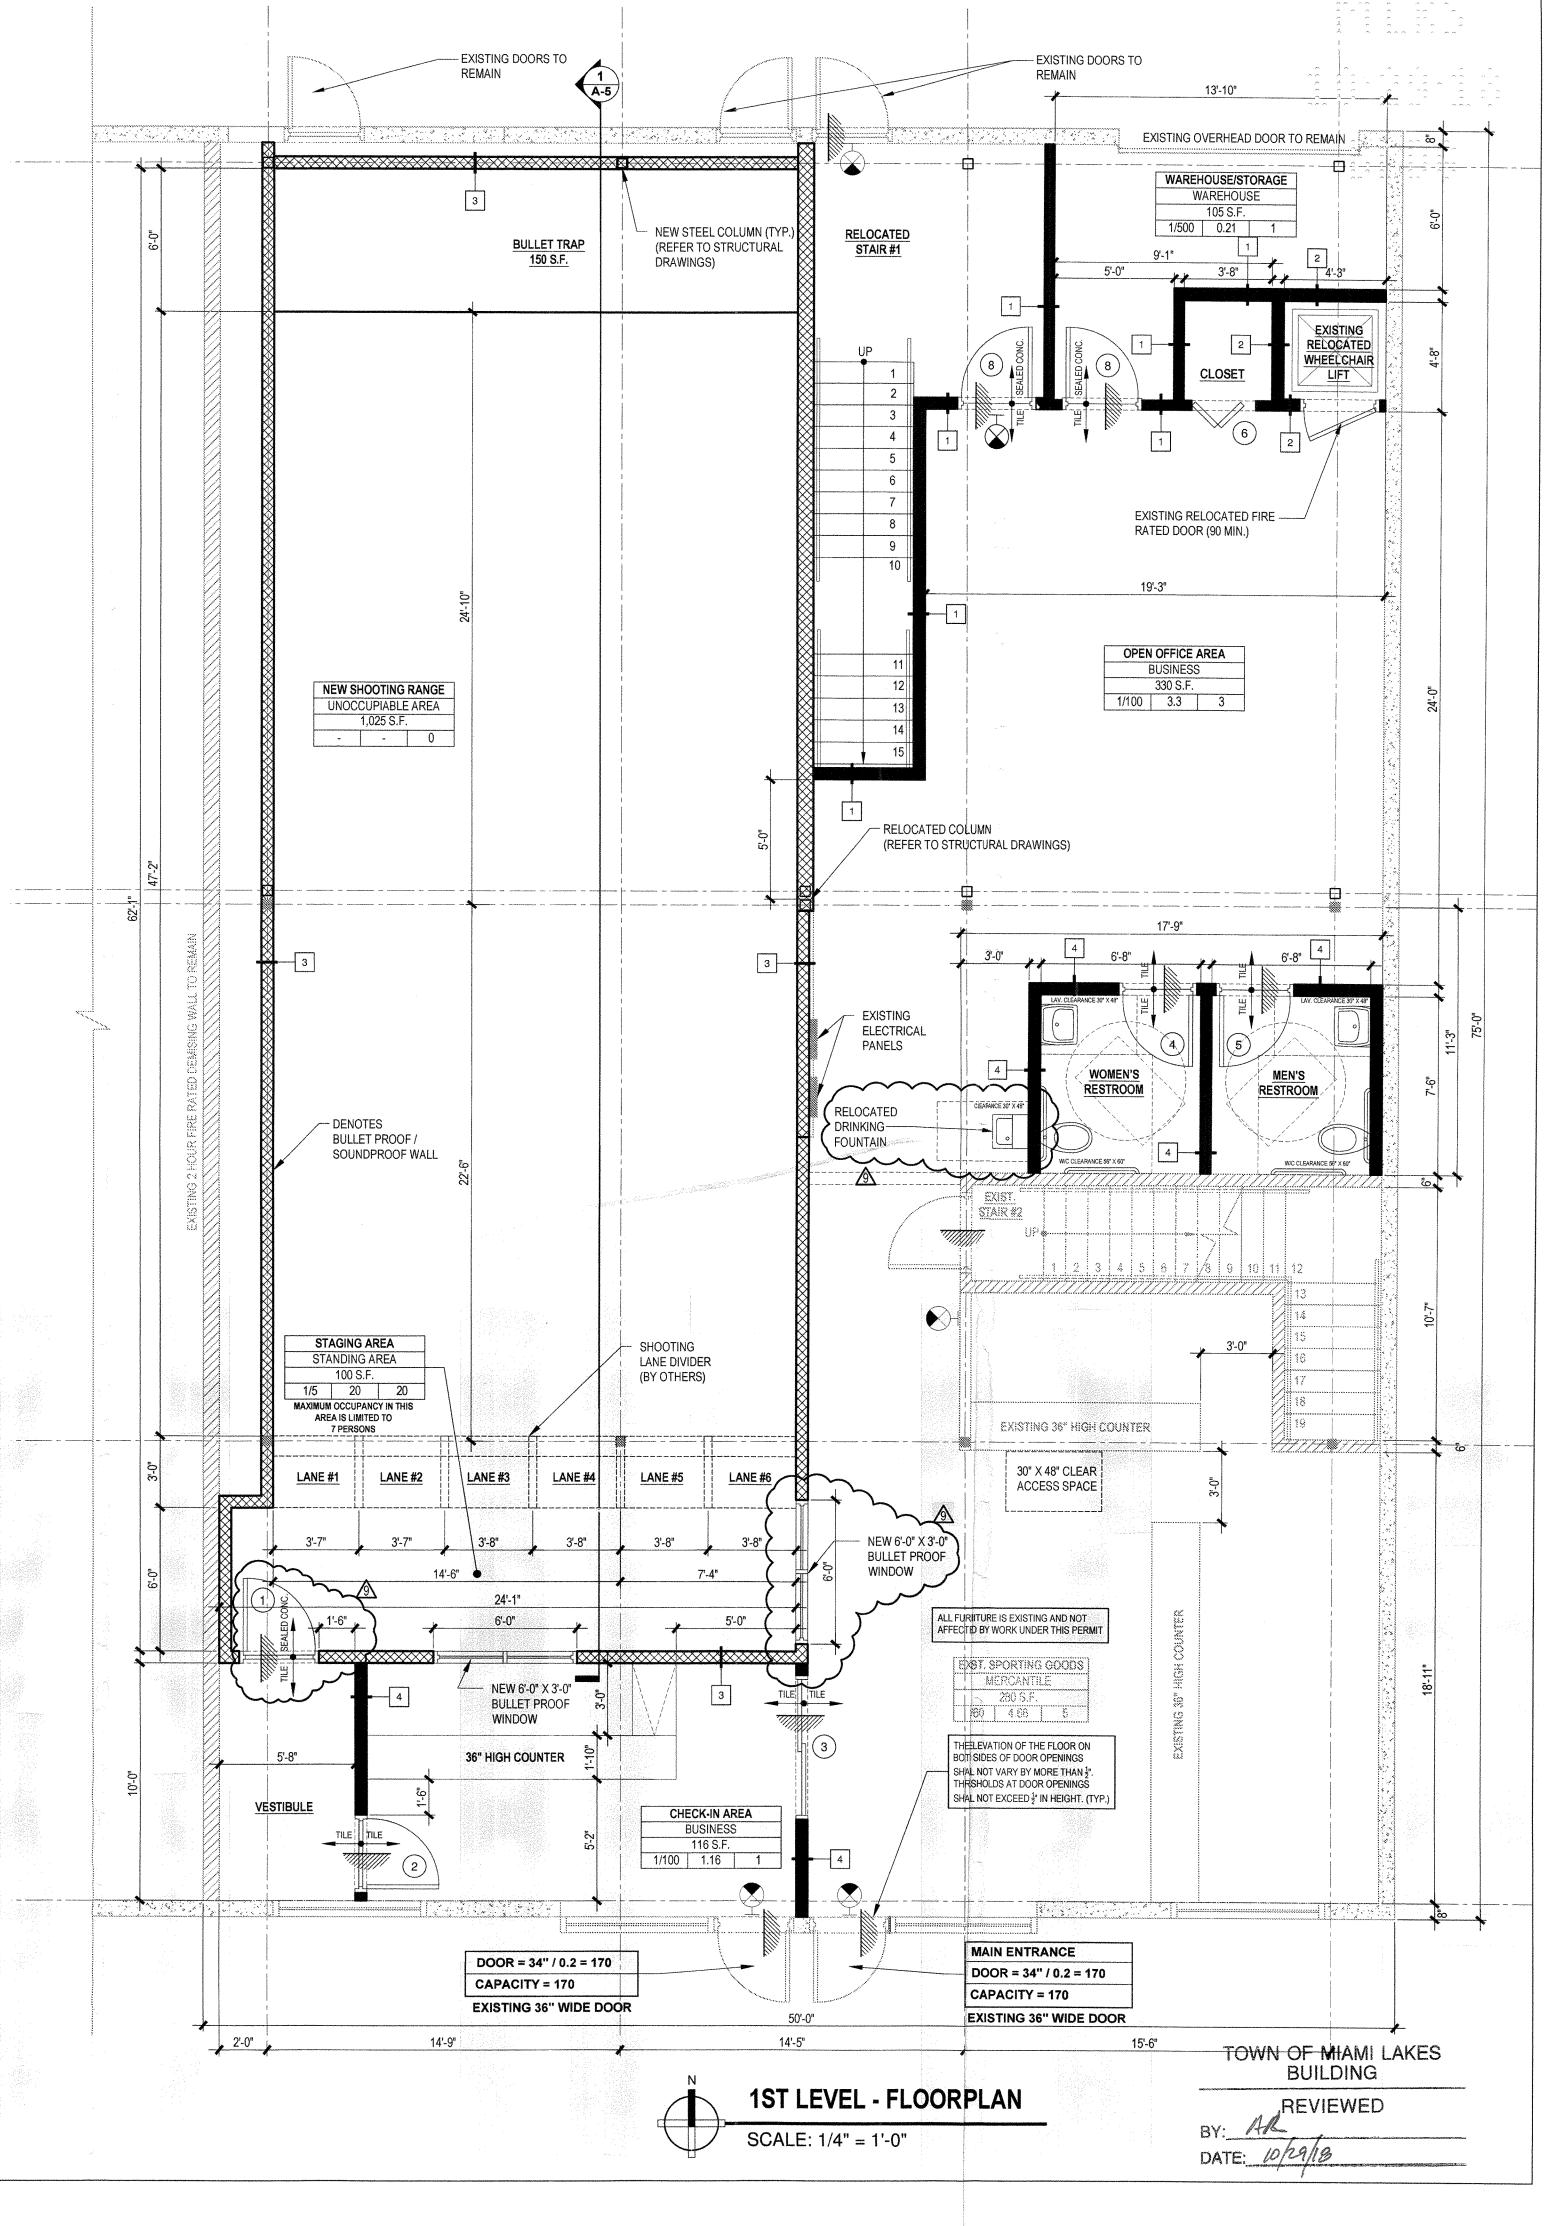



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POLICE AND

ISSUES: DATE: PERMIT SET 05-31-16 A BLDG / FIRE DEPT COMMENTS 09-06-16 ⚠ BLDG / FIRE DEPT COMMENTS 11-23-16 6 OWNER CHANGES 06-23-17 FIRE DEPT COMMENTS 09-13-17 8\OWNER CHANGES 04-13-18 9\OWNER CHANGES 10-23-18

DRAWING TITLE **1ST LEVEL FLOOR PLAN**

PROJECT NO.

SHEET

INTERIOR STUD FRAMING LIMITATIONS CHART

THIS DATA IS BASED ON THE "U.S. GYPSUM CO." PRODUCT DATA FOR THE PURPOSE OF LIMITING THE HEIGHTS OF UNBRACED PARTITIONS. THE USE OF THIS DATA IS TO SET A MAXIMUM HEIGHT STANDARD FOR SUCH PARTITIONS.

				PARTITIONS.		TO SET A
	T			STUD FRAMING	TABLE 1	- CHEONO
STUD DESIGN	STUD WIDTH	STUD SPACING	ALLOW. DEFL.	PARTITION HEIGHT ONE LAYER 5/8"	PARTITION HEIGHT TWO LAYERS 5/8"	FURRING ONE LAYER 5/8
25 GAUGI	E (.0179	MIN.)	p norm manuscon normanica manuscon normanica manuscon normanica manuscon normanica manuscon n		,	
158ST25	1 5/8"	16"	L/360 L/360	9'6" d 8'3" d	10'6" d 9'0" d	8'3" d 7'3" d
		24"	L/360 L/360	8'3" d 7'3" d	8'9" f 8'0" d	7'3" d 6'3" d
212ST25	2 1/2"	16"	L/360 L/360	12'6" d 10'9" d	13'6" d 11'9" d	11'0" d 9'9" d
		24"	L/360 L/360	10'9" d 9'6" d	11'3" f 10'3" d	9'9" d 8'6" d
358ST25	3 5/8"	16"	L/360 L/360	16'0" d 14'0" d	16'9" f 14'9" d	14'6" d* 12'9" d*
		24"	L/360 L/360	13'6" f 12'3" d	13'6" f 13'0" d	12'9" d* 11'0" d
400ST25	4"	16"	L/360 L/360	17'3" d 15'0" d	17'3" f 15'9" d	15'9" d* 13'9" d
		24"	L/360 L/360	14'3" f 13'0" d	14'3" f 13'9" d	13'9" d* 12'0" d
600ST25	6"	16"	L/360 L/360	20'0" f 20'0" f	20'0" f 20'0" f	20'0" f* 18'9" f
		24"	L/360 L/360	15'0" v 15'0" v	15'0" v 15'0" v	15'0" v* 15'0" v*
22 GAUGE	E (.0270	MIN.)				
212ST22	2 1/2"	16"	L/360 L/360	13'0" d 11'6" d	14'0" d 12'3" d	12'0" d 10'6" d
		24"	L/360 L/360	11'6" d 10'0" d	12'3" d 10'6" d	10'6" d 9'3" d
358ST22	3 5/8"	16"	16" L/360 17'3" d 18'0" d L/360 15'0" d 15'9" d		16'0" d* 14'0" d*	
		24"	L/360 L/360	15'0" d 13'0" d	15'9" d 13'9" d	14'0" d* 12'3" d*
400ST22	4"	16"	L/360 L/360	18'6" d 16'3" d	19'3" d 16'9" d	17'3" d* 15'0" d
		24"	L/360 L/360	16'3" d 14'0" d	16'9" d 14'9" d	15'0" d* 13'3" d
600ST22	6"	16"	L/360 L/360	25'3" d 22'0" d	26'0" d 22'9" d	23'9" d* 20'9" d
		24"	L/360 L/360	22'0" d 19'3" d	22'9" d 19'9" d	20'9" d* 18'3" d*
20 GAUGI	Т	Y				***************************************
212ST22	2 1/2"	16"	L/360 L/360	14'0" d 12'3" d	14'9" d 13'0" d	13'0" d* 11'6" d
		24"	L/360 L/360	12'3" d 10'9" d	13'0" d 11'3" d	11'6" d 10'0" d
358ST22	3 5/8"	16"	L/360 L/360	18'3" d 16'0" d	19'0" d 16'6" d	17'3" d* 15'0" d*
		24"	L/360 L/360	16'0" d 14'0" d	16'6" d 14'6" d	15'0" d* 13'3" d
400ST22	4"	16"	L/360 L/360	19'6" d 17'3" d	20'3" d 17'9" d	18'9" d* 16'3" d
	And a contract of the contract	24"	L/360 L/360	17'3" d 15'0" d	17'9" d 15'6" d	16'3" d* 14'3" d*
600ST22	6"	16"	L/360 L/360	26'6" d 23'3" d	27'6" d 24'0" d	25'6" d* 22'3" d*
		24"	L/360 L/360	23'3" d 20'3" d	24'0" d 21'0" d	22'3" d* 19'6" d*


TYPICAL LIMITING HEIGHTS - CHASE WALL PARTITIONS TABLE 2

20 GAUGE (.0329 MIN.)

STUD DESIGN	STUD WIDTH	STUD SPACING		PARTITION HEIGHT GWB BOTH SIDES	PARTITION HEIGHT GWB ONE SIDE
600CH20	6"	24"	L/360	20 ' 11" d	21'2" d

NOTES:

- 1. LIMITING HEIGHT FOR 5/8" GYPSUM PANELS AND 5 PSF UNIFORM LOAD PERPENDICULAR TO PARTITION OR FURRING.
- 2. USE ONE-LAYER HEIGHTS FOR UNBALANCED ASSEMBLIES. USE TWO-LAYER HEIGHTS FOR
- 3. FOR FURRING, STUD ATTACHED TO TOP AND BOTTOM RUNNERS AND FREE-STANDING UP TO 12'-0" HEIGHT.
- 4. *STUDS EXCEEDING 12'-0" HEIGHT REQUIRE MID-HEIGHT ANCHOR TO EXTERIOR WALL. ASSEMBLIES WITHOUT FACE PANELS AND CHASE WALLS PARTITIONS REQUIRE VERTICAL CROSS BRACES 4'-0" O.C. MAX. LIMITING CRITERIA D-DEFLECTION, F-BENDING STRESS. V-END REACTION SHEAR.
- 5. THE TYPICAL PHYSICAL AND STRUCTURAL PROPERTIES AND APPLICABLE TABLES PUBLISHED WITH THIS CHART REPRESENT CHARACTERISTICS AND/OR STEEL STUDS CURRENTLY AVAILABLE FROM A GROUP OF STEEL STUD MANUFACTURERS.
- 6. GENERAL CONTRACTOR TO CONSULT STUD MANUFACTURER FOR ACTUAL PHYSICAL AND STRUCTURAL PROPERTIES, STUD THICKNESSES AND LIMITING HEIGHT TABLES TO DETERMINE FINAL STUD SELECTION.

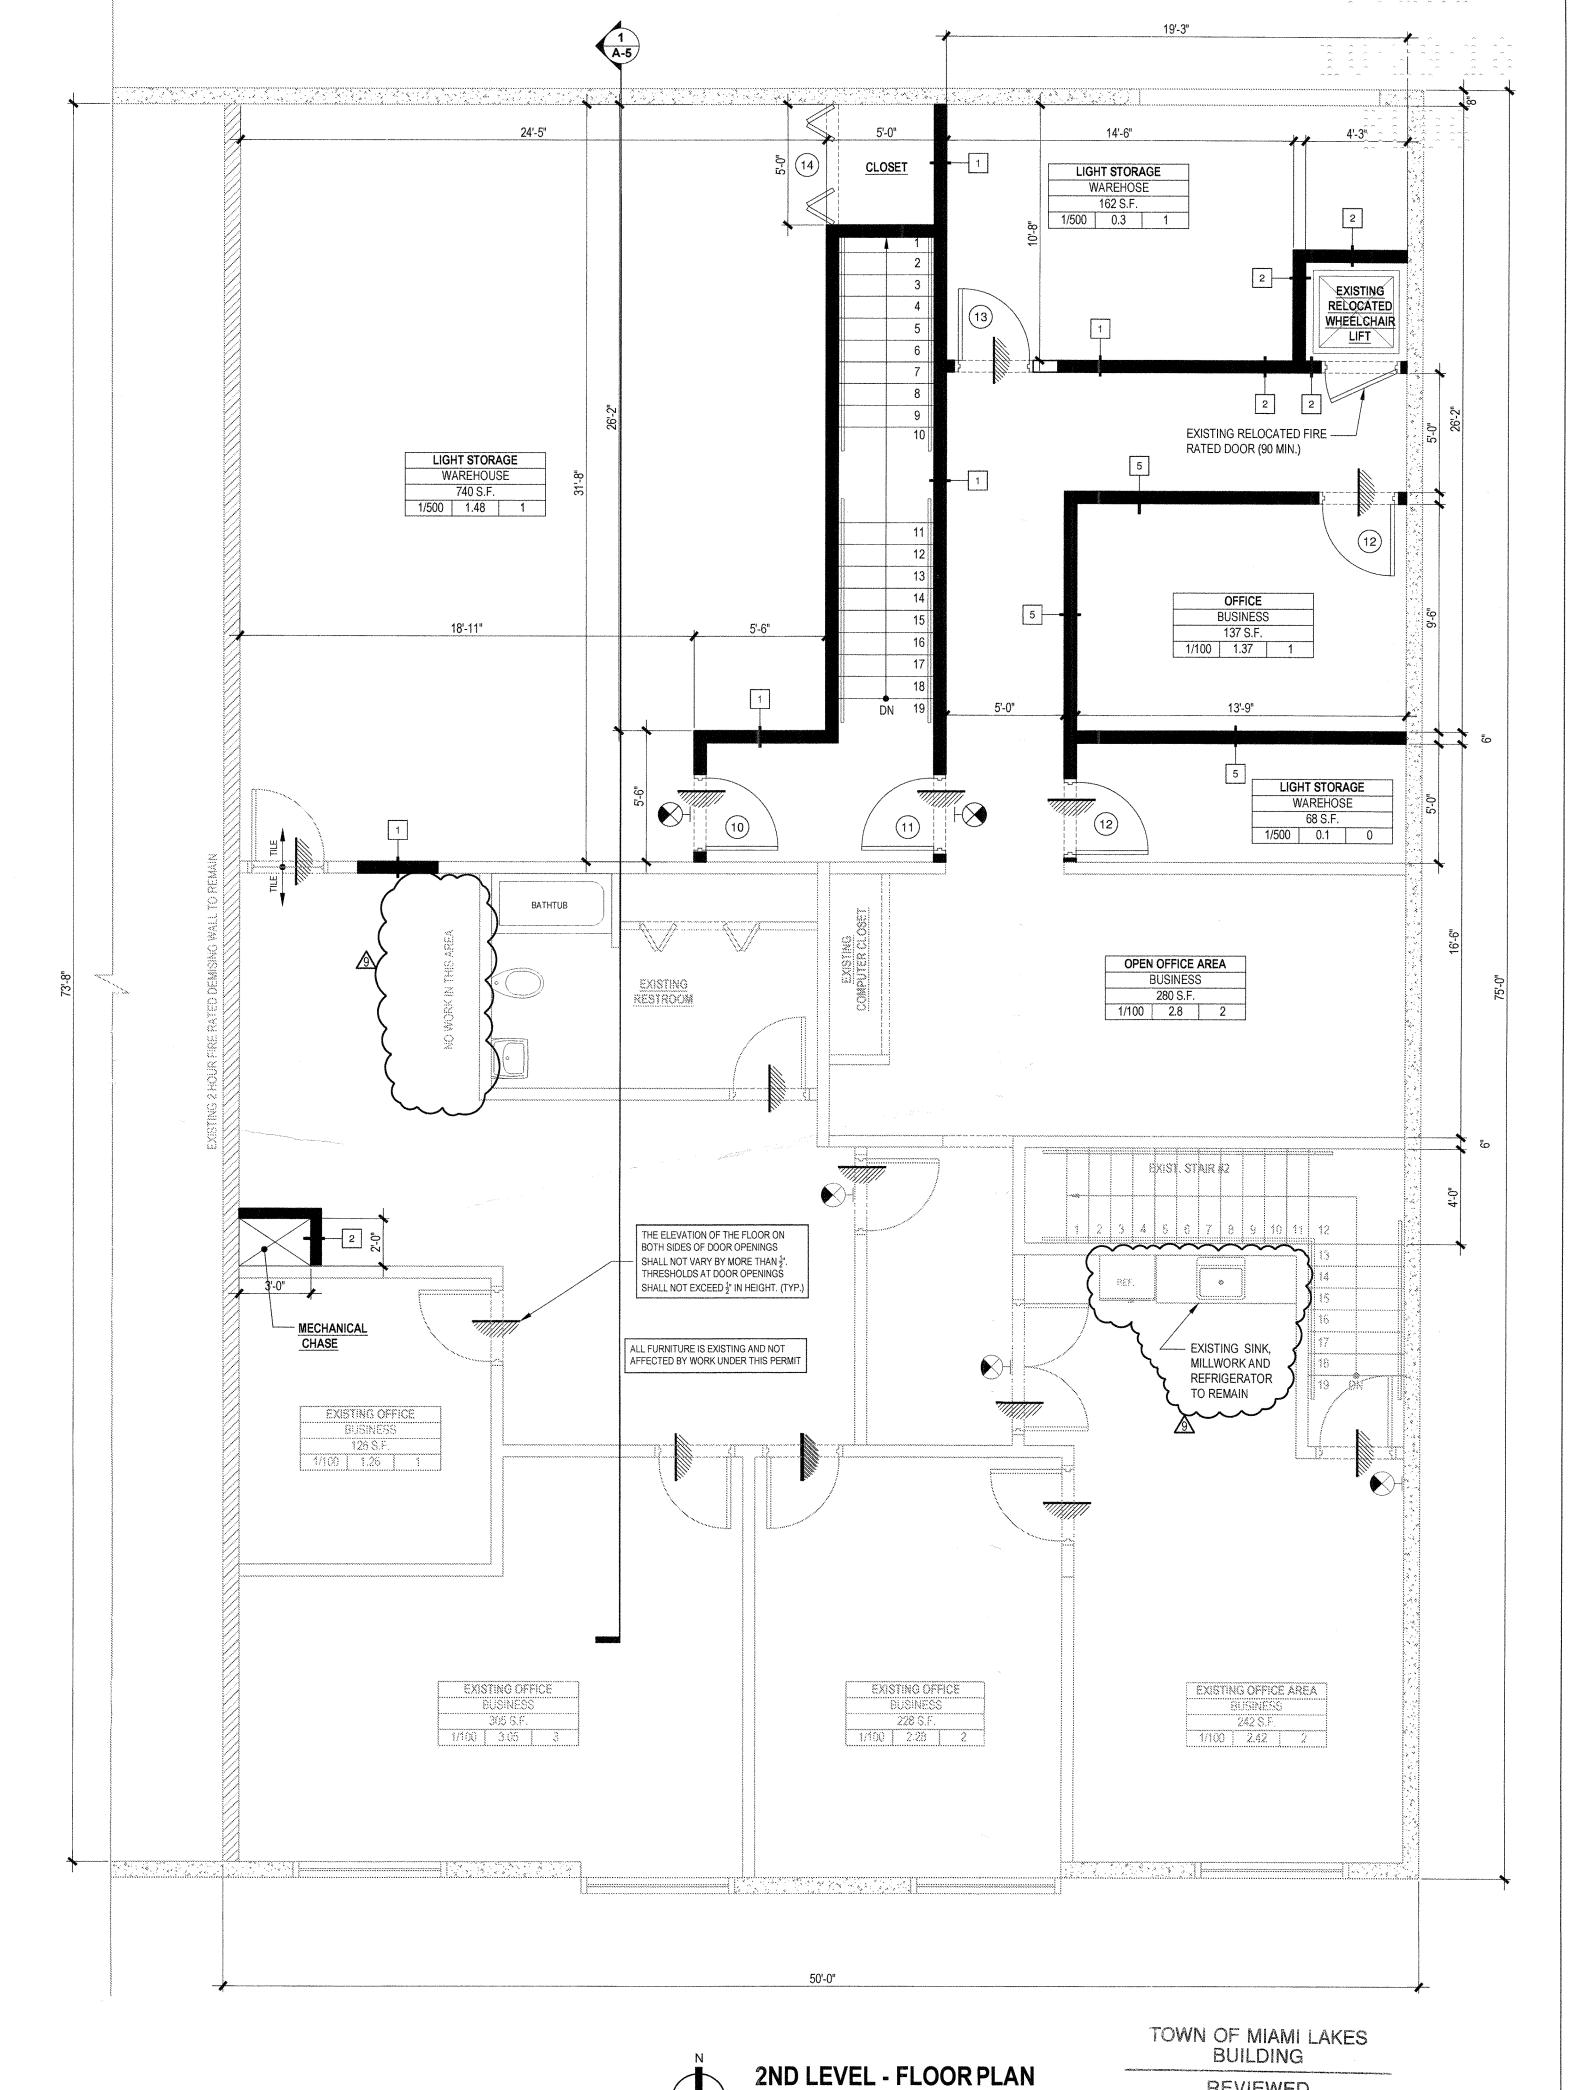

SCALE: 1/4" = 1'-0"



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Tel. 305-826-6377 AND IMPROVEMENTS FOR

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Y'S POLICE AND

INDOOR SHOOTING RANGE

DANIEL E. DIEZ, R.A. AR0017269

ISSUES: DATE: PERMIT SET 05-31-16 BLDG / FIRE DEPT COMMENTS 09-06-16 BLDG / FIRE DEPT COMMENTS 11-23-16 6 OWNER CHANGES 8 OWNER CHANGES 04-13-18 9 OWNER CHANGES 10-23-18

DRAWING TITLE **2ND LEVEL FLOOR PLAN**

PROJECT NO. 14-35

SHEET

REVIEWED

DATE: 10/29/18

REVZ018-3976 14000-1400Z NW 8Z AVE.

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