


ELEVATE CHURCH

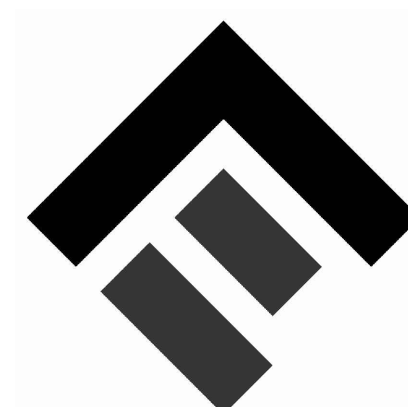

ELEVATE CHURCH

6250 MIAMI LAKES DR.
MIAMI LAKES, FL 33014

6250 MIAMI LAKES DR.
MIAMI LAKES, FL 33014

| | | |
|--|--|--|
| | | |
| | | |
| | | |
| | | |
| | | |
| | | |

| △ | DATE | REVISION |
|---|------|----------|
|---|------|----------|

DWG. TITLE

COVER

SCALE

N.T.S.

PROJECT NO.

2014-30

DATE _____

03-14-17

SHEET NUMBER

A-000

74000



LEGEND:

- CATCH BASIN
- WATER METER
- CONCRETE POLE
- STREET LAMP
- EXISTING ELEVATION
- FIRE HYDRANT
- CENTER LINE
- AIR CONDITIONER

ABBREVIATIONS:

- | | |
|--------|-------------------------|
| FIP | FOUND IRON PIPE |
| N&D | NAIL AND DISC |
| C&G | CURB AND GUTTER |
| F.F.E. | FINISH FLOOR ELEVATION |
| ID | IDENTIFICATION |
| R= | RADIUS |
| L= | ARC LENGTH |
| Δ= | INTERIOR ANGLE OF CURVE |
| T= | TANGENT |


SKETCH OF SURVEY

PREPARED BY:
GUNTER GROUP, INC.
LAND SURVEYING - LAND PLANNING
FLORIDA CERTIFICATE OF AUTHORIZATION NO. LB 4507
9350 S.W. 22nd TERRACE
MIAMI, FLORIDA 33165
(305) 220-0073



LOCATION MAP

NOT TO SCALE

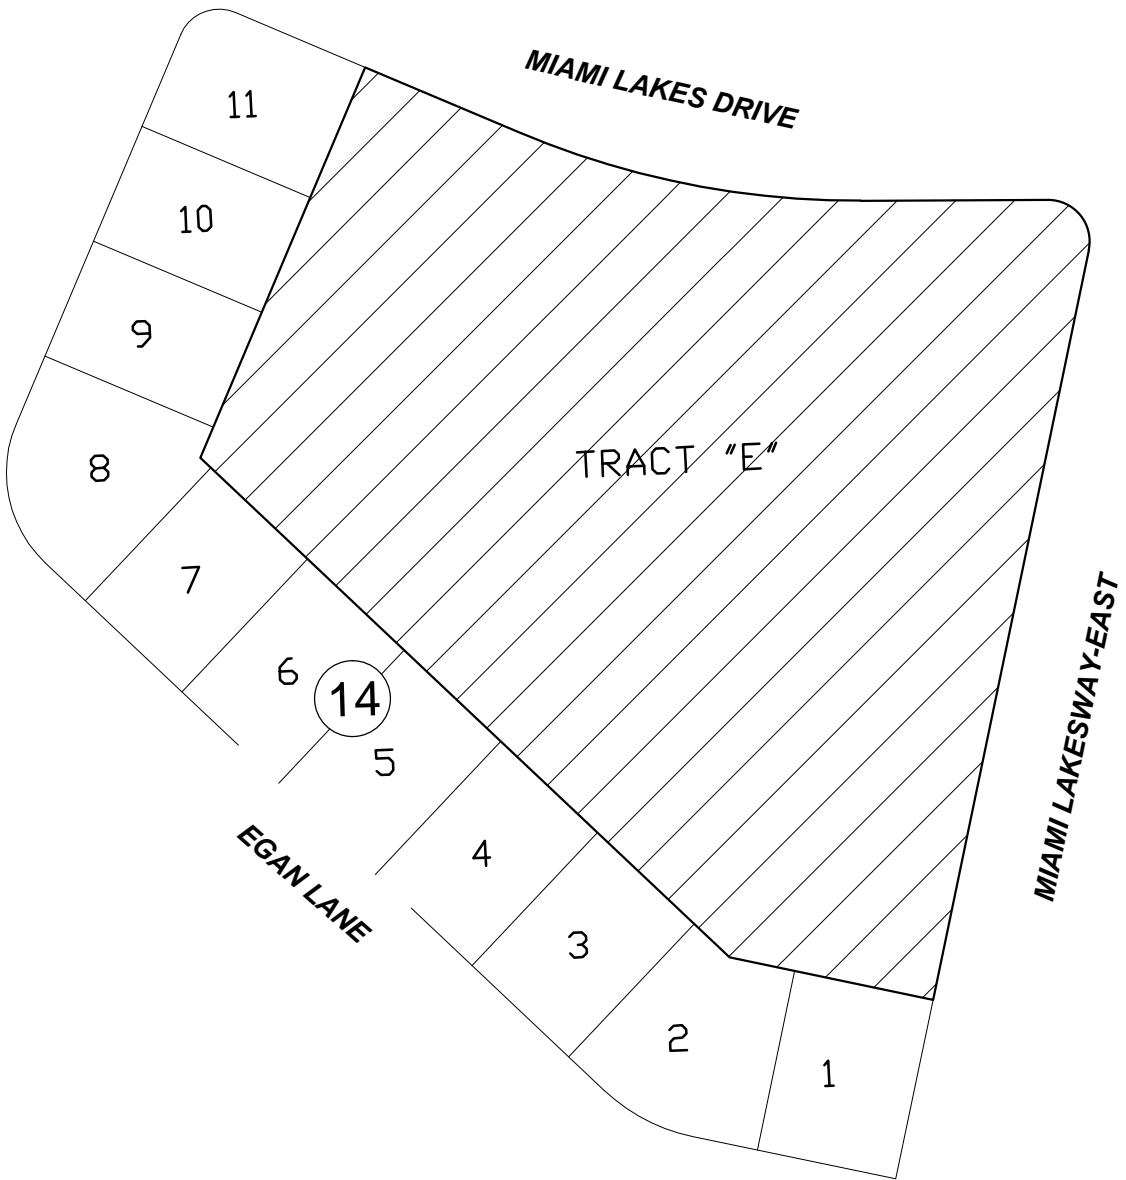

PROPERTY ADDRESS:

6250 Miami Lakes Drive Miami Lakes, Florida 33014.

LEGAL DESCRIPTION:

Tract E of MIAMI LAKES SECTION THREE; according to the Plat thereof as recorded in Plat Book 78 at Page 47 of the Public Records of Miami-Dade County, Florida.

FOR:

MIAMI LAKES BAPTIST CHURCH.

SURVEYOR'S NOTES:

- 1) This survey was conducted for the purpose of a "Topographic Survey" only and is not intended to delineate the regulatory jurisdiction of any federal, state, regional or local agency, board, commission or other entity.
- 2) The accuracy obtained by measurements and calculations on this survey, meets and exceeds the Minimum Technical Standards requirements for a Suburban area (1 foot in 7,500 feet) as specified in Chapter 5J-17, Florida Administrative Code.
- 3) Bearings shown hereon are based on an assumed meridian of X89°45'00"E along the Northerly boundary line of the subject property.
- 4) The North arrow direction shown herein is based on an assumed Meridian.
- 5) In some cases graphic representation have exaggerated to more clearly illustrate a particular area where dimensions shall have preference over graphic location.
- 6) Legal description was provided by the client and is subject to any dedications, limitations, restrictions reservations or easements of record.
- 7) Examination of the Abstract of Title will have to be made to determine recorded instruments, if any affecting the property; search of Public Records not performed by this office.
- 8) No effort was made by this office to locate any underground utilities and/or structures within or abutting the subject property.
- 9) This survey has been prepared for the exclusive use of the entities named hereon only and the certifications hereon do not extend to any unnamed parties.
- 10) Elevations shown referred to N.G.V. Datum 1929, Miami-Dade County benchmark No. "N-666", elevation 7.95 feet; located at E. Miami Lakes Drive (± NW 150 Street) (31 feet North of edge of pavement); Miami Lakeway N. (± NW 62 Avenue) (80 feet East of center line); 10 feet East of FPL Meter on a pedestal; 18.5 feet East SE of a Bell Telephone MH; PK Nail and Brass washer in the SW corner of a 9'X10' concrete; Support for Bell Telephone Junction Box.
- 11) According to the National Flood Insurance Program the subject property falls in Community No. 120686, Panel No. 0116, Suffix "L". Date of FIRM 09-11-2009, Flood Zone "X".
- 12) Contact the appropriate authorities prior to any design work on the hereon-described parcel for Building and Zoning information.
- 13) Professional Land Surveyor and Mapper in responsible charge: Rolando Ortiz LS 4312, State of Florida.
- 14) This survey is not valid without the signature and the raised seal of a Florida Licensed Land Surveyor and Mapper.

I hereby certify to **MIAMI LAKES BAPTIST CHURCH** that the Sketch of Topographic Survey of the described property is true and correct to the best of my knowledge and belief, as recently surveyed and platted under my direction; also that meets the Minimum Technical Standards set in Chapter 5J-17, Florida Administrative Code, pursuant to Section 472.027 Florida Statutes.

Date: 12-23-2014
Job No.: 93-5408
Sketch No. 5111

By: Rolando Ortiz LS 4312
Professional Land Surveyor
& Mapper, State of Florida.




VIEW 5



VIEW 4



VIEW 3

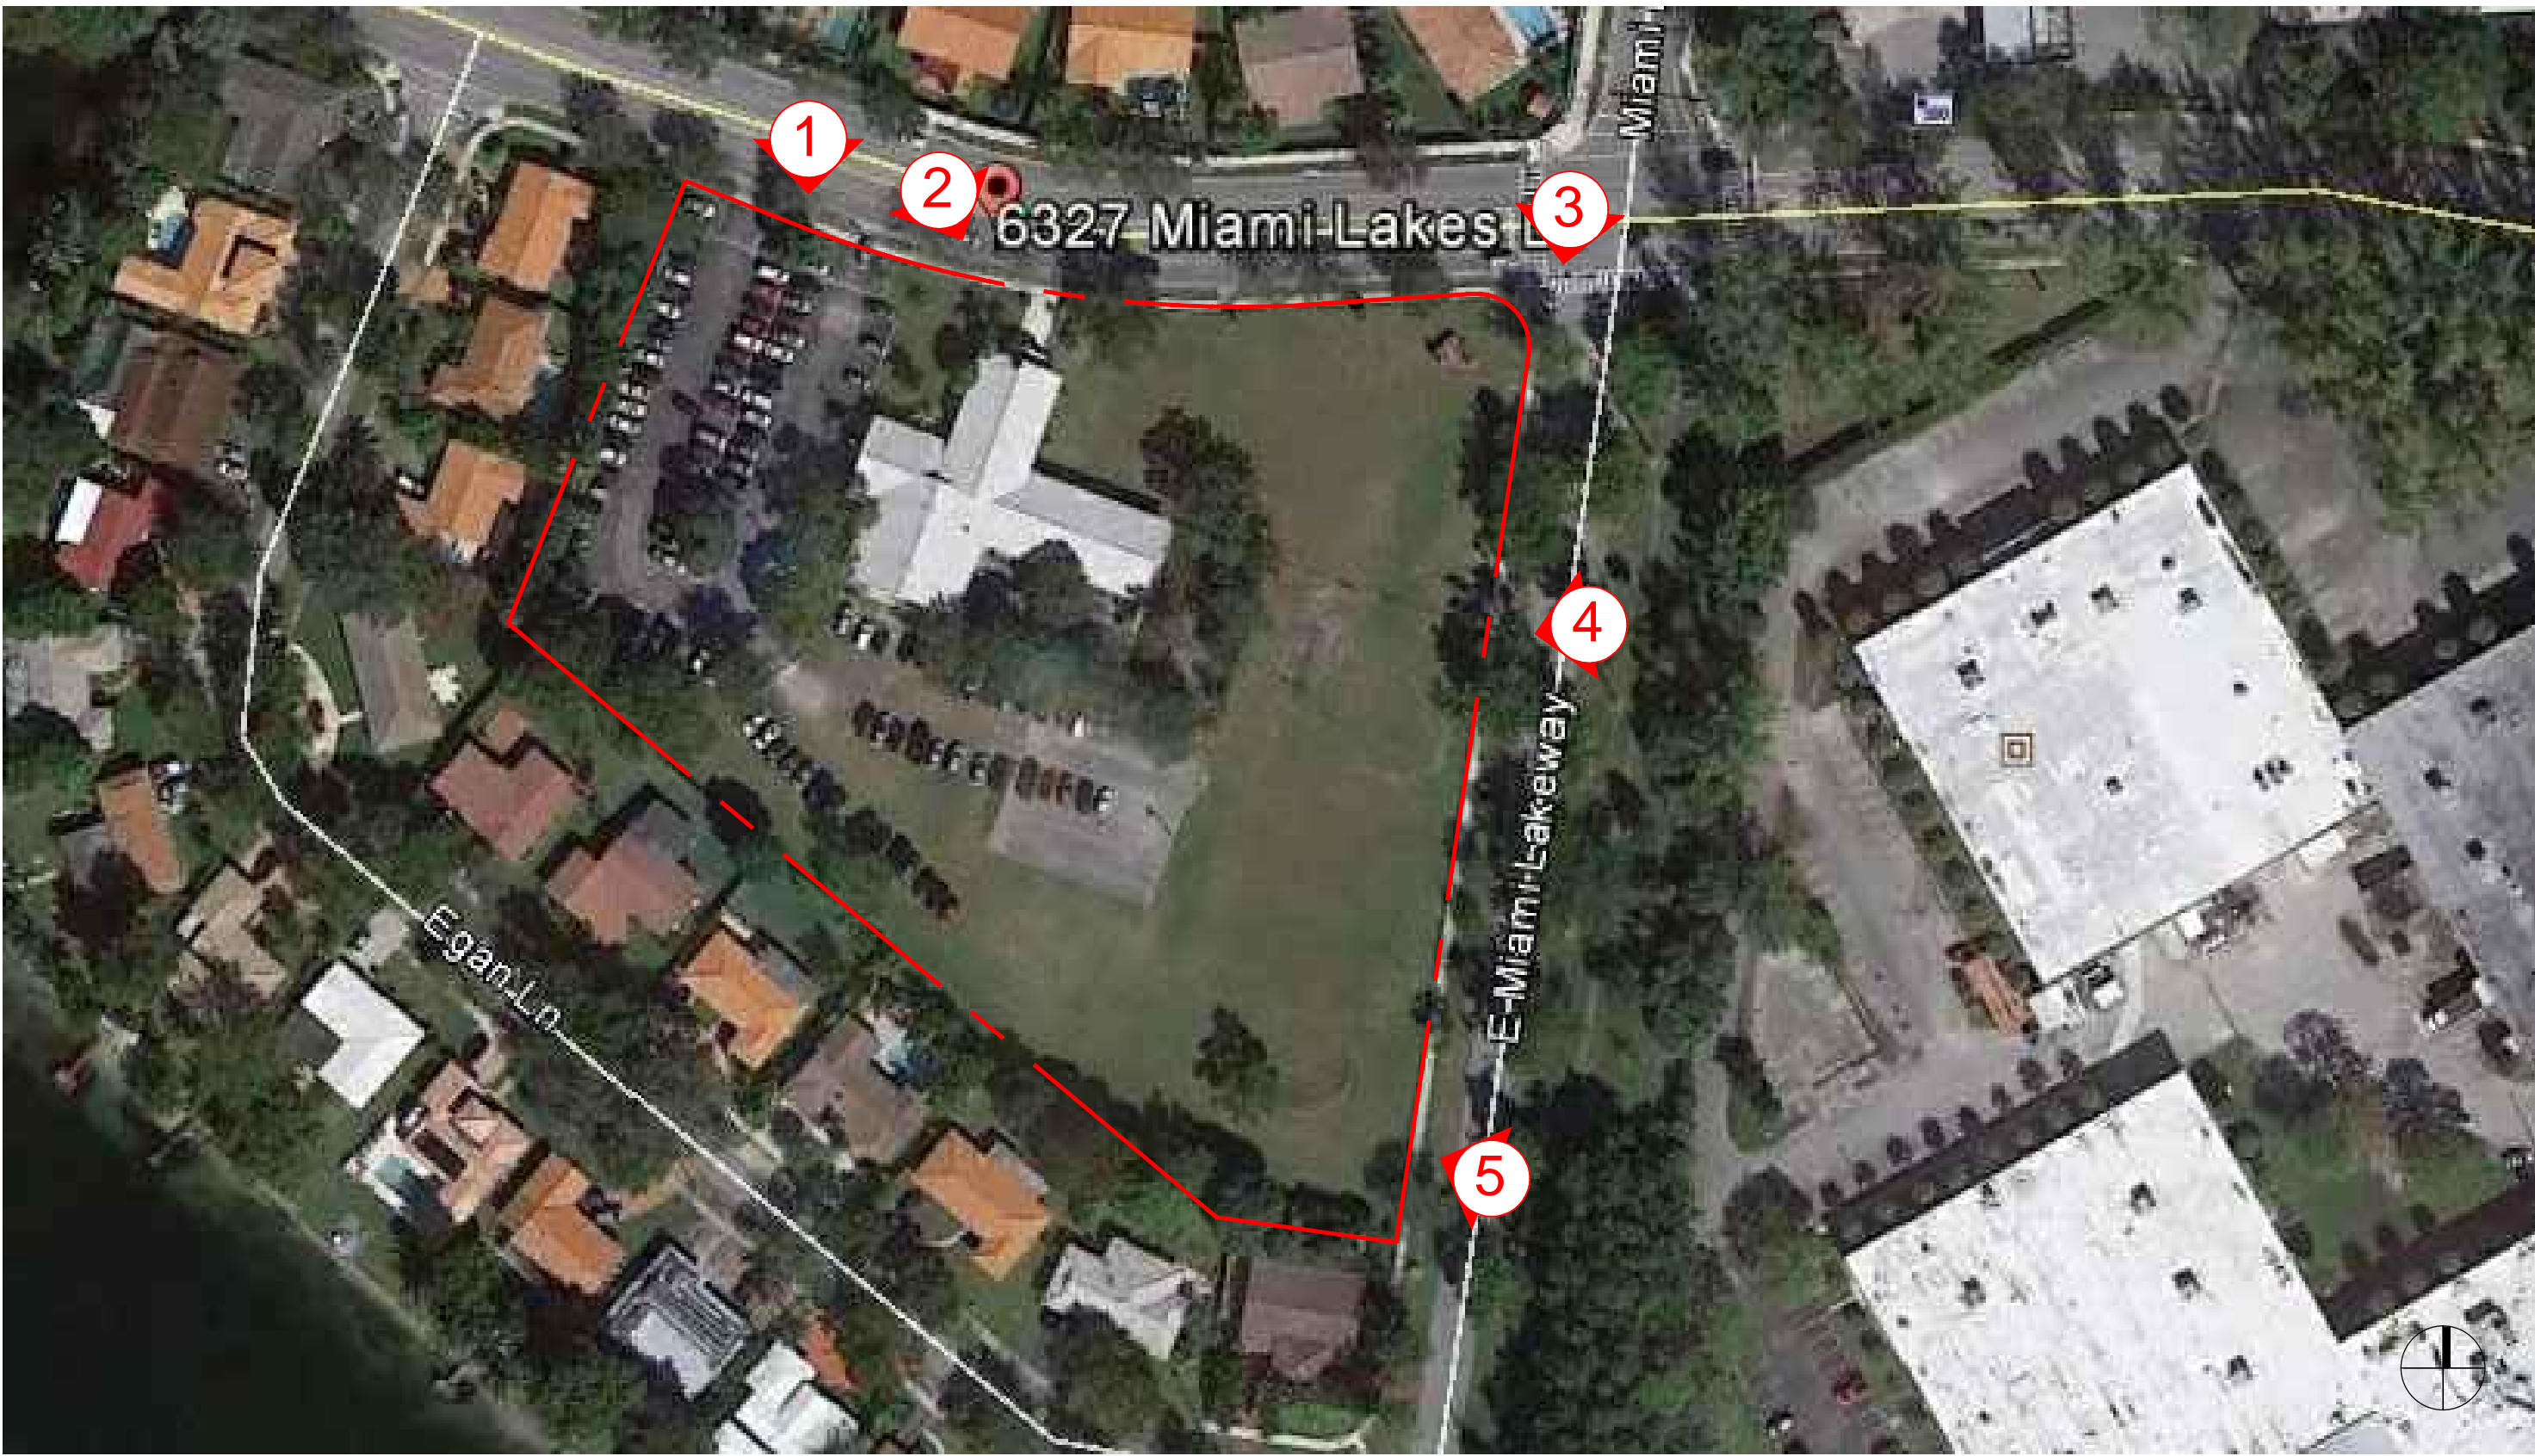


SITE AERIAL



VIEW 1




VIEW 2

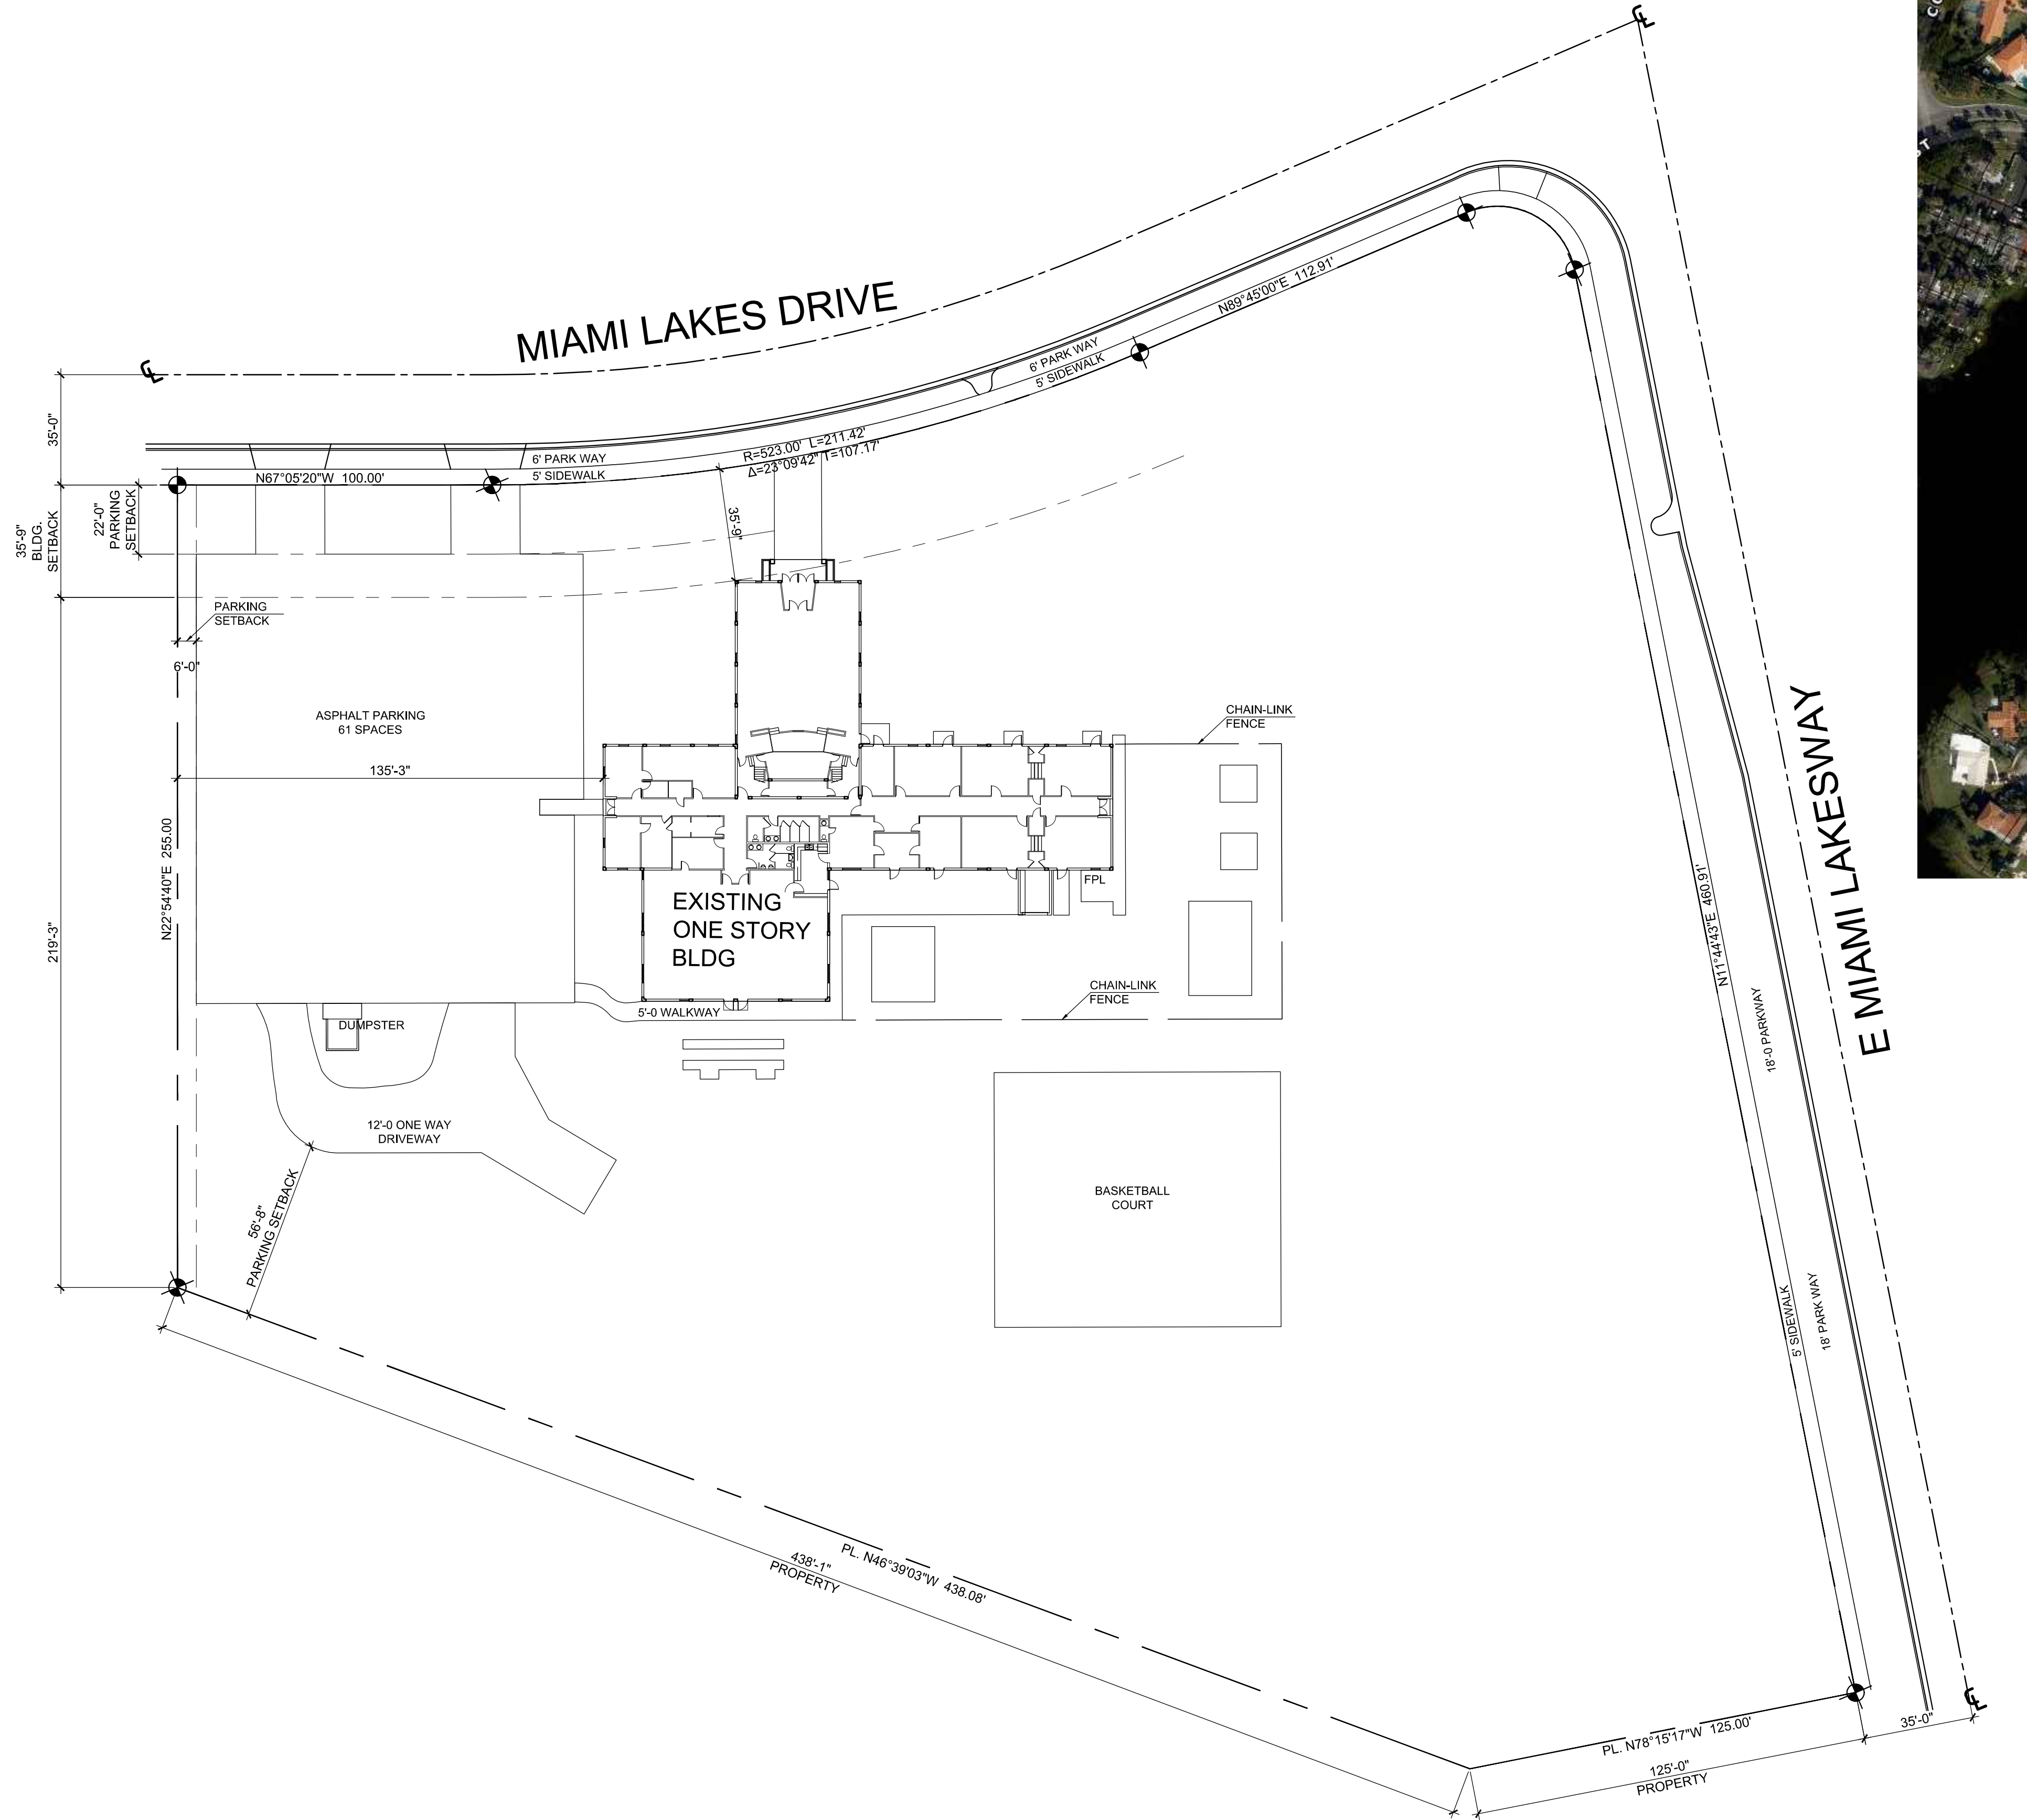

EXISTING SITE PLAN

SCALE: 1/32" = 1'-0"

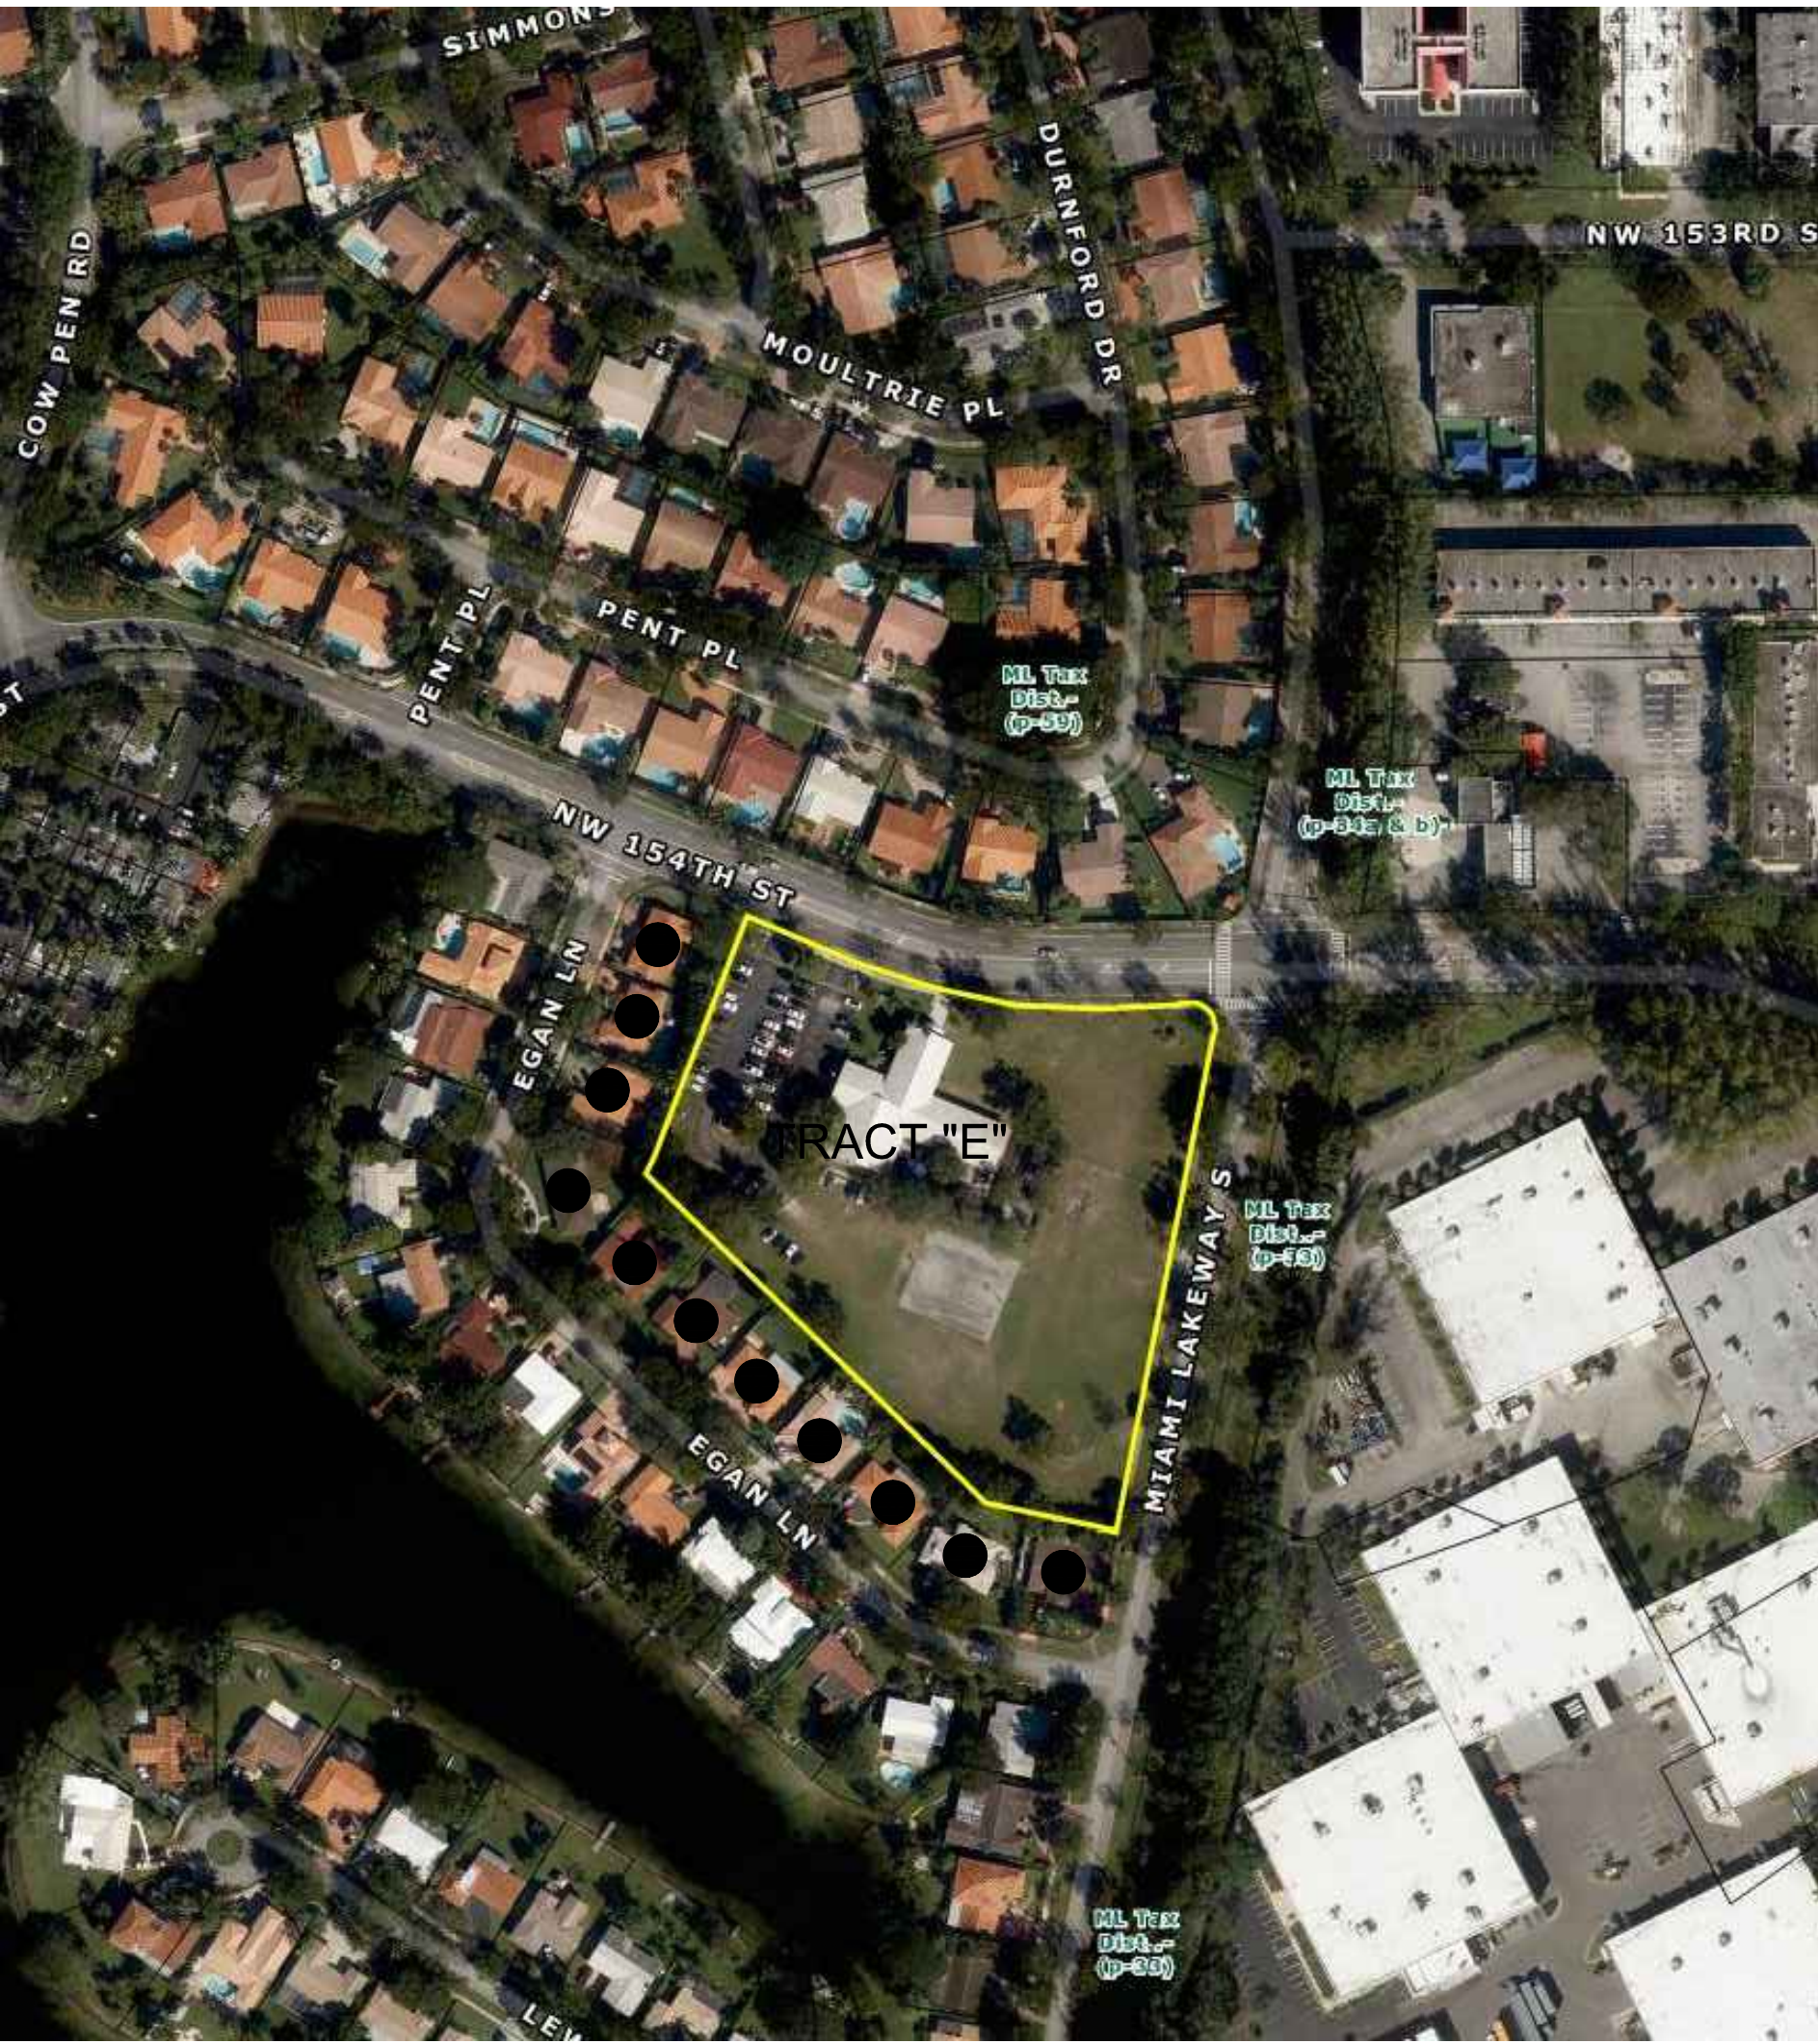

LOCATION PLAN

SCALE: N.T.S.

ELEVATE CHURCH

6250 MIAMI LAKES DR.
MIAMI LAKES, FL 33014

DATE REVISION

DWG. TITLE

EXISTING
SITE PLAN

SCALE

AS SHOWN

PROJECT NO.

2014-30

DATE

03-14-17

SHEET NUMBER

SP-EXSIT.

BEILLINSON
GOMEZ
ARCHITECTS
ARCHITECTURE AAC001062
JOSE L. GOMEZ AR0015416
8101 BISCAYNE BLVD.
SUITE 309
MIAMI FL 33138-4664
TEL (305) 559-1250
FAX (305) 551-1740
beilinsonarchitectspa.com

COPYRIGHT 2014. ALL RIGHTS RESERVED. THESE DRAWINGS AND DOCUMENTS ARE INSTRUMENTS OF SERVICE. SERVICE SHALL REMAIN THE PROPERTY OF BEILLINSON GOMEZ ARCHITECTS P.A. WHETHER THE PROJECT FOR WHICH THEY WERE PREPARED IS EXECUTED OR NOT. THEY ARE NOT TO BE USED IN ANY MANNER OR OTHER PROJECTS OR EXTENSIONS TO THE PROJECT WITHOUT THE WRITTEN CONSENT OF BEILLINSON GOMEZ ARCHITECTS P.A. IT IS THE RESPONSIBILITY OF THE CLIENT TO OBTAIN ALL NECESSARY PERMITS AND APPROVALS PRIOR TO PROCEEDING WITH WORK.

| Item | ZONING INFORMATION | | | | | |
|------|--|----------------|--|---|----------------------------|--|
| 1 | Address: | | 6250 MIAMI LAKES DR. MIAMI LAKES, FL 33014 | | | |
| 2 | Folio number(s) | | 32-2024-008-1300 | | | |
| 3 | Year built | | 1967 | Zoning District | | IUC - INDUSTRIAL DISTRICT, CONDITIONAL |
| 4 | Based Flood Elevation | | NGVD | Grade Value in NGVD | | NGVD |
| 5 | Lot Gross Area (SF) | | 217,605.6 | 4.92 ACRES | Net Lot Area (SF) | 182,986.50/4.20 ACRES |
| 6 | Lot Width | | REFER TO SURVEY | | Lot Depth | REFER TO SURVEY |
| 7 | Existing Bldg. - Gross (SF) | | 11,299.00 | | New Sanctuary - Gross (SF) | 17,040.00 |
| | | ALLOW/REQUIRED | EXISITNG BLDG | | | PROPOSED (EXISTING & NEW SANCTUARY) |
| 8 | Lot coverage (SF) | | N/A | 11,351.70 | 6.20% | 17,670.50 9.66% |
| 9 | FAR | | N/A | N/A | | N/A |
| 10 | Unit Size | | N/A | N/A | | N/A |
| 11 | Bldg. Height (No greater than the width of widest street abutting) | | 35'-0"MAX. | 21'-2"(to Top of Roof) | | 30'-0" (to Top of Parapet) |
| | Church Spire Height Exception | | | 42'-4"(to Top of Tower Cap) | | 40'-0" (to Top of Spire) |
| 12 | Number of Stories | | - | 1 STORY | | 2 STORY (New Sanctuary) |
| 13 | Landscaped Open Space 20% Net Lot Area | | 36,597.30 | 138,180.80 | 75.51% | 75,282.40 41.14% |
| 14 | Impervios (Asphalt/concrete areas) | | | 33,454.00 | 18.28% | 78,681.90 43.00% |
| | SETBACKS | REQUIRED | EXISITNG BLDG (REFER TO SURVEY) | | | PROPOSED (EXISTING & NEW SANCTUARY) |
| 15 | Front Setback (North) | | 15% of 255.00' | 35'-9" | EXISTING TO REMAIN | 38'-4" - |
| 16 | Street Side Setback (East) | | 25'-0" | 172'-11.5" | - | 25'-0" - |
| 17 | Interior Side Setback (West) | | 10'-0" | 135'-3" | EXISTING TO REMAIN | 135'-3" EXISTING TO REMAIN |
| 18 | Rear Setback | | 20'-0" | 136'-6" | EXISTING TO REMAIN | 136'-6" EXISTING TO REMAIN |
| | PARKING | REQUIRED | EXISITNG | | | PROPOSED (EXISTING & NEW SANCTUARY) |
| 19 | Front Setback (North) | | 25'-0" | 22'-0" | - | 25'-0" - |
| 20 | Street Setback (East) | | 10'-0" | N/A | - | 10'-0" GREENBELT |
| 21 | Interior Side Setback (West) | | 5'-0" | 6'-0" | - | 10'-0" GREENBELT |
| 22 | Rear Setback | | 5'-0" | 56'-8" | - | 10'-0" GREENBELT |
| 23 | Parking Spaces (1 Space 50 sf of Sitting Area) | | 172 SPACES | 1,723 SF (EXISTING)+6,856. SF (NEW SANCTUARY)= 8,579 SF TOTAL SITTING AREA | | 185 SPACES TOTAL |
| 24 | Bicycle Racks Spaces (12/101-501 Parking Spaces) | | 12 SPACES | 0 | | 12 SPACES |
| 26 | Located within a Local Historic District? | | | | | Yes or No |
| 27 | Designated as an individual Historic Single Family Residence Site? | | | | | Yes or No |
| 28 | Determined to be Architecturally Significant? | | | | | Yes or No |

BEILINSON
GOMEZ

ARCHITECTS P.A.

ARCHITECTURE AAC001062
JOSE L. GOMEZ AR001516
8101 BISCAYNE BLVD.
SUITE 309
MIAMI FL 33138-4664
TEL. (305) 559.1250
FAX (305) 551.1740
beilinsonarchitectspa.com

MIAMI LAKES DRIVE

MIAMI LAKEWAY EAST

TRACK "E"

LOCATION MAP

SCALE: N.T.S.

SITE PLAN LEGEND

EXISTING BUILDING

NEW SANCTUARY

LANDSCAPE

SIDEWALK

ASPHALT/ PARKING

DATE

REVISION

DWG. TITLE

SITE PLAN

SCALE

1/32"=1'-0"

PROJECT NO.


2014-30

DATE

03-14-17

SHEET NUMBER

SP-101

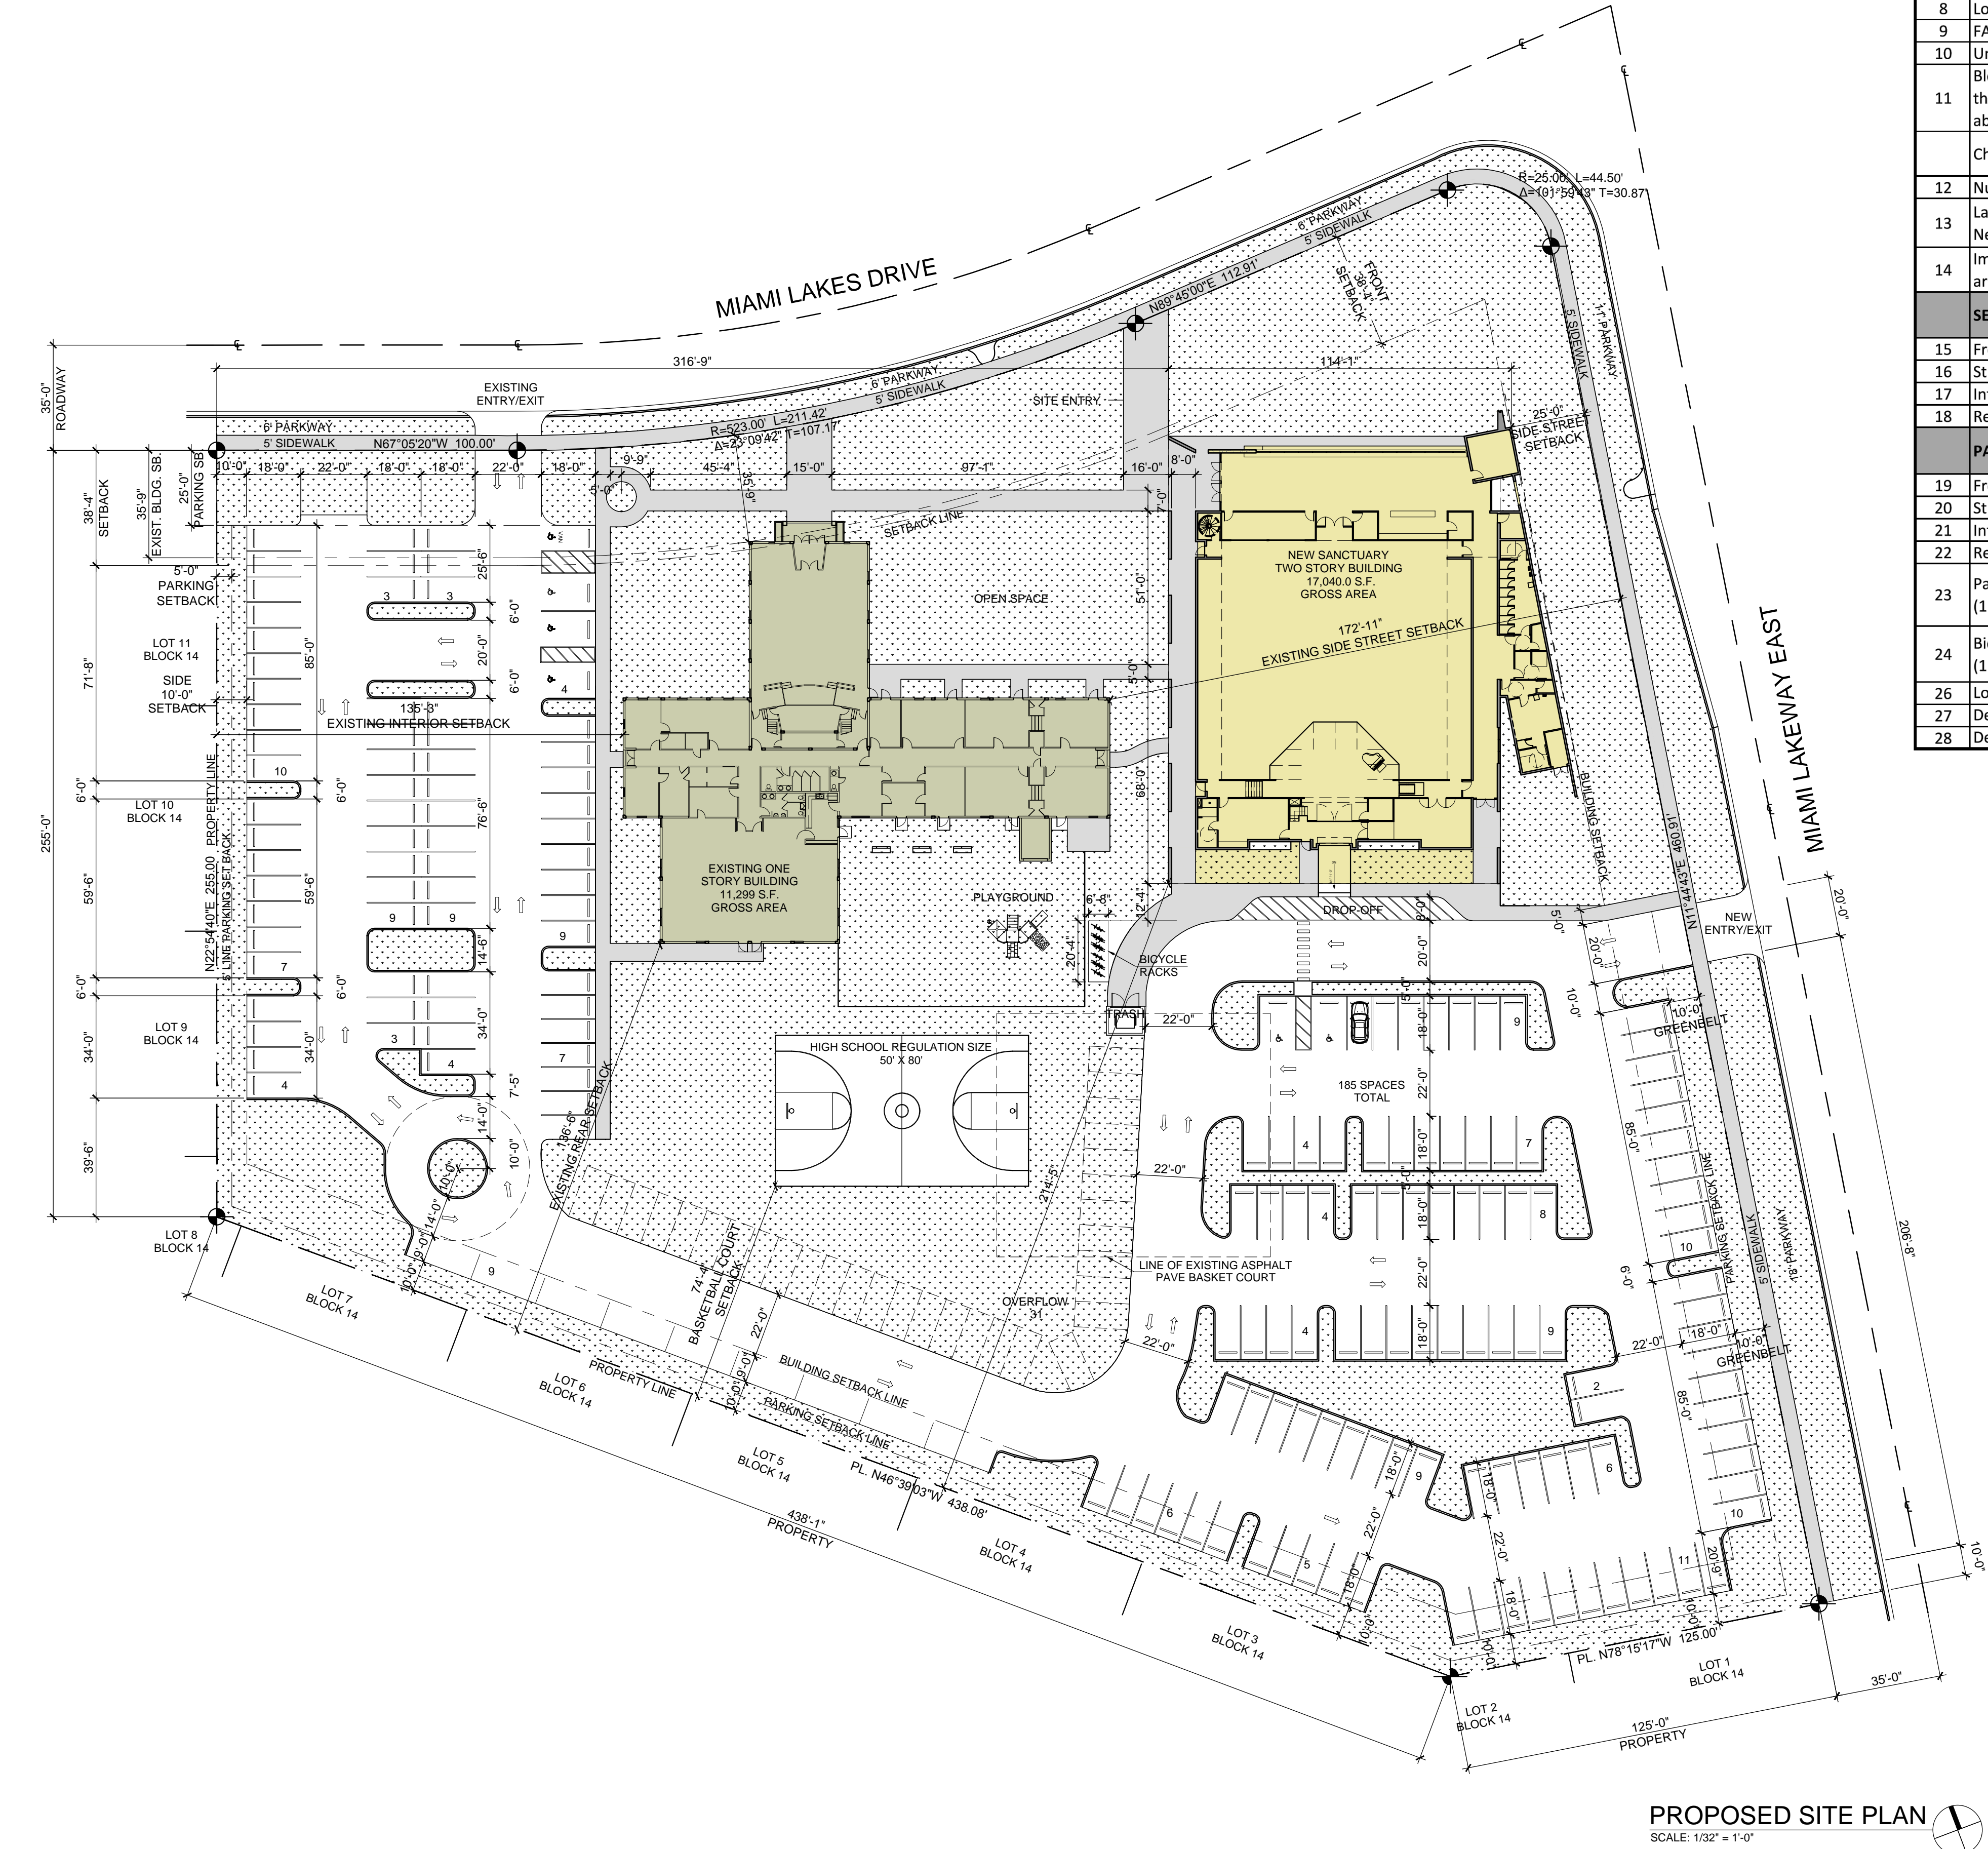

COPYRIGHT 2014. ALL RIGHTS RESERVED. THESE DRAWINGS AND DOCUMENTS ARE INSTRUMENTS OF SERVICE. BEILINSON GOMEZ ARCHITECTS P.A. REMAINS THE PROPERTY OF BEILINSON GOMEZ ARCHITECTS P.A. WHETHER THE PROJECT FOR WHICH THEY WERE PREPARED IS EXECUTED OR NOT. THEY ARE NOT TO BE USED IN ANY MANNER, ON OTHER PROJECTS OR EXTENDED TO THIS PROJECT WITHOUT THE WRITTEN CONSENT OF BEILINSON GOMEZ ARCHITECTS P.A. BEILINSON GOMEZ ARCHITECTS P.A. IS NOT RESPONSIBLE FOR ANY ERRORS OR OMISSIONS IN THESE DRAWINGS OR DOCUMENTS. CONTRACTORS RESPONSIBLE FOR VERIFYING ALL LIFE CONDITIONS PRIOR TO PROCEEDING WITH WORK.

ELEVATE CHURCH
6250 MIAMI LAKES DR.
MIAMI LAKES, FL 33014

DATE REVISION

DWG. TITLE

GROUND
FLOOR PLAN

SCALE

1/8"=1'-0"

PROJECT NO.


2014-30

DATE

03-14-17

SHEET NUMBER

A-101

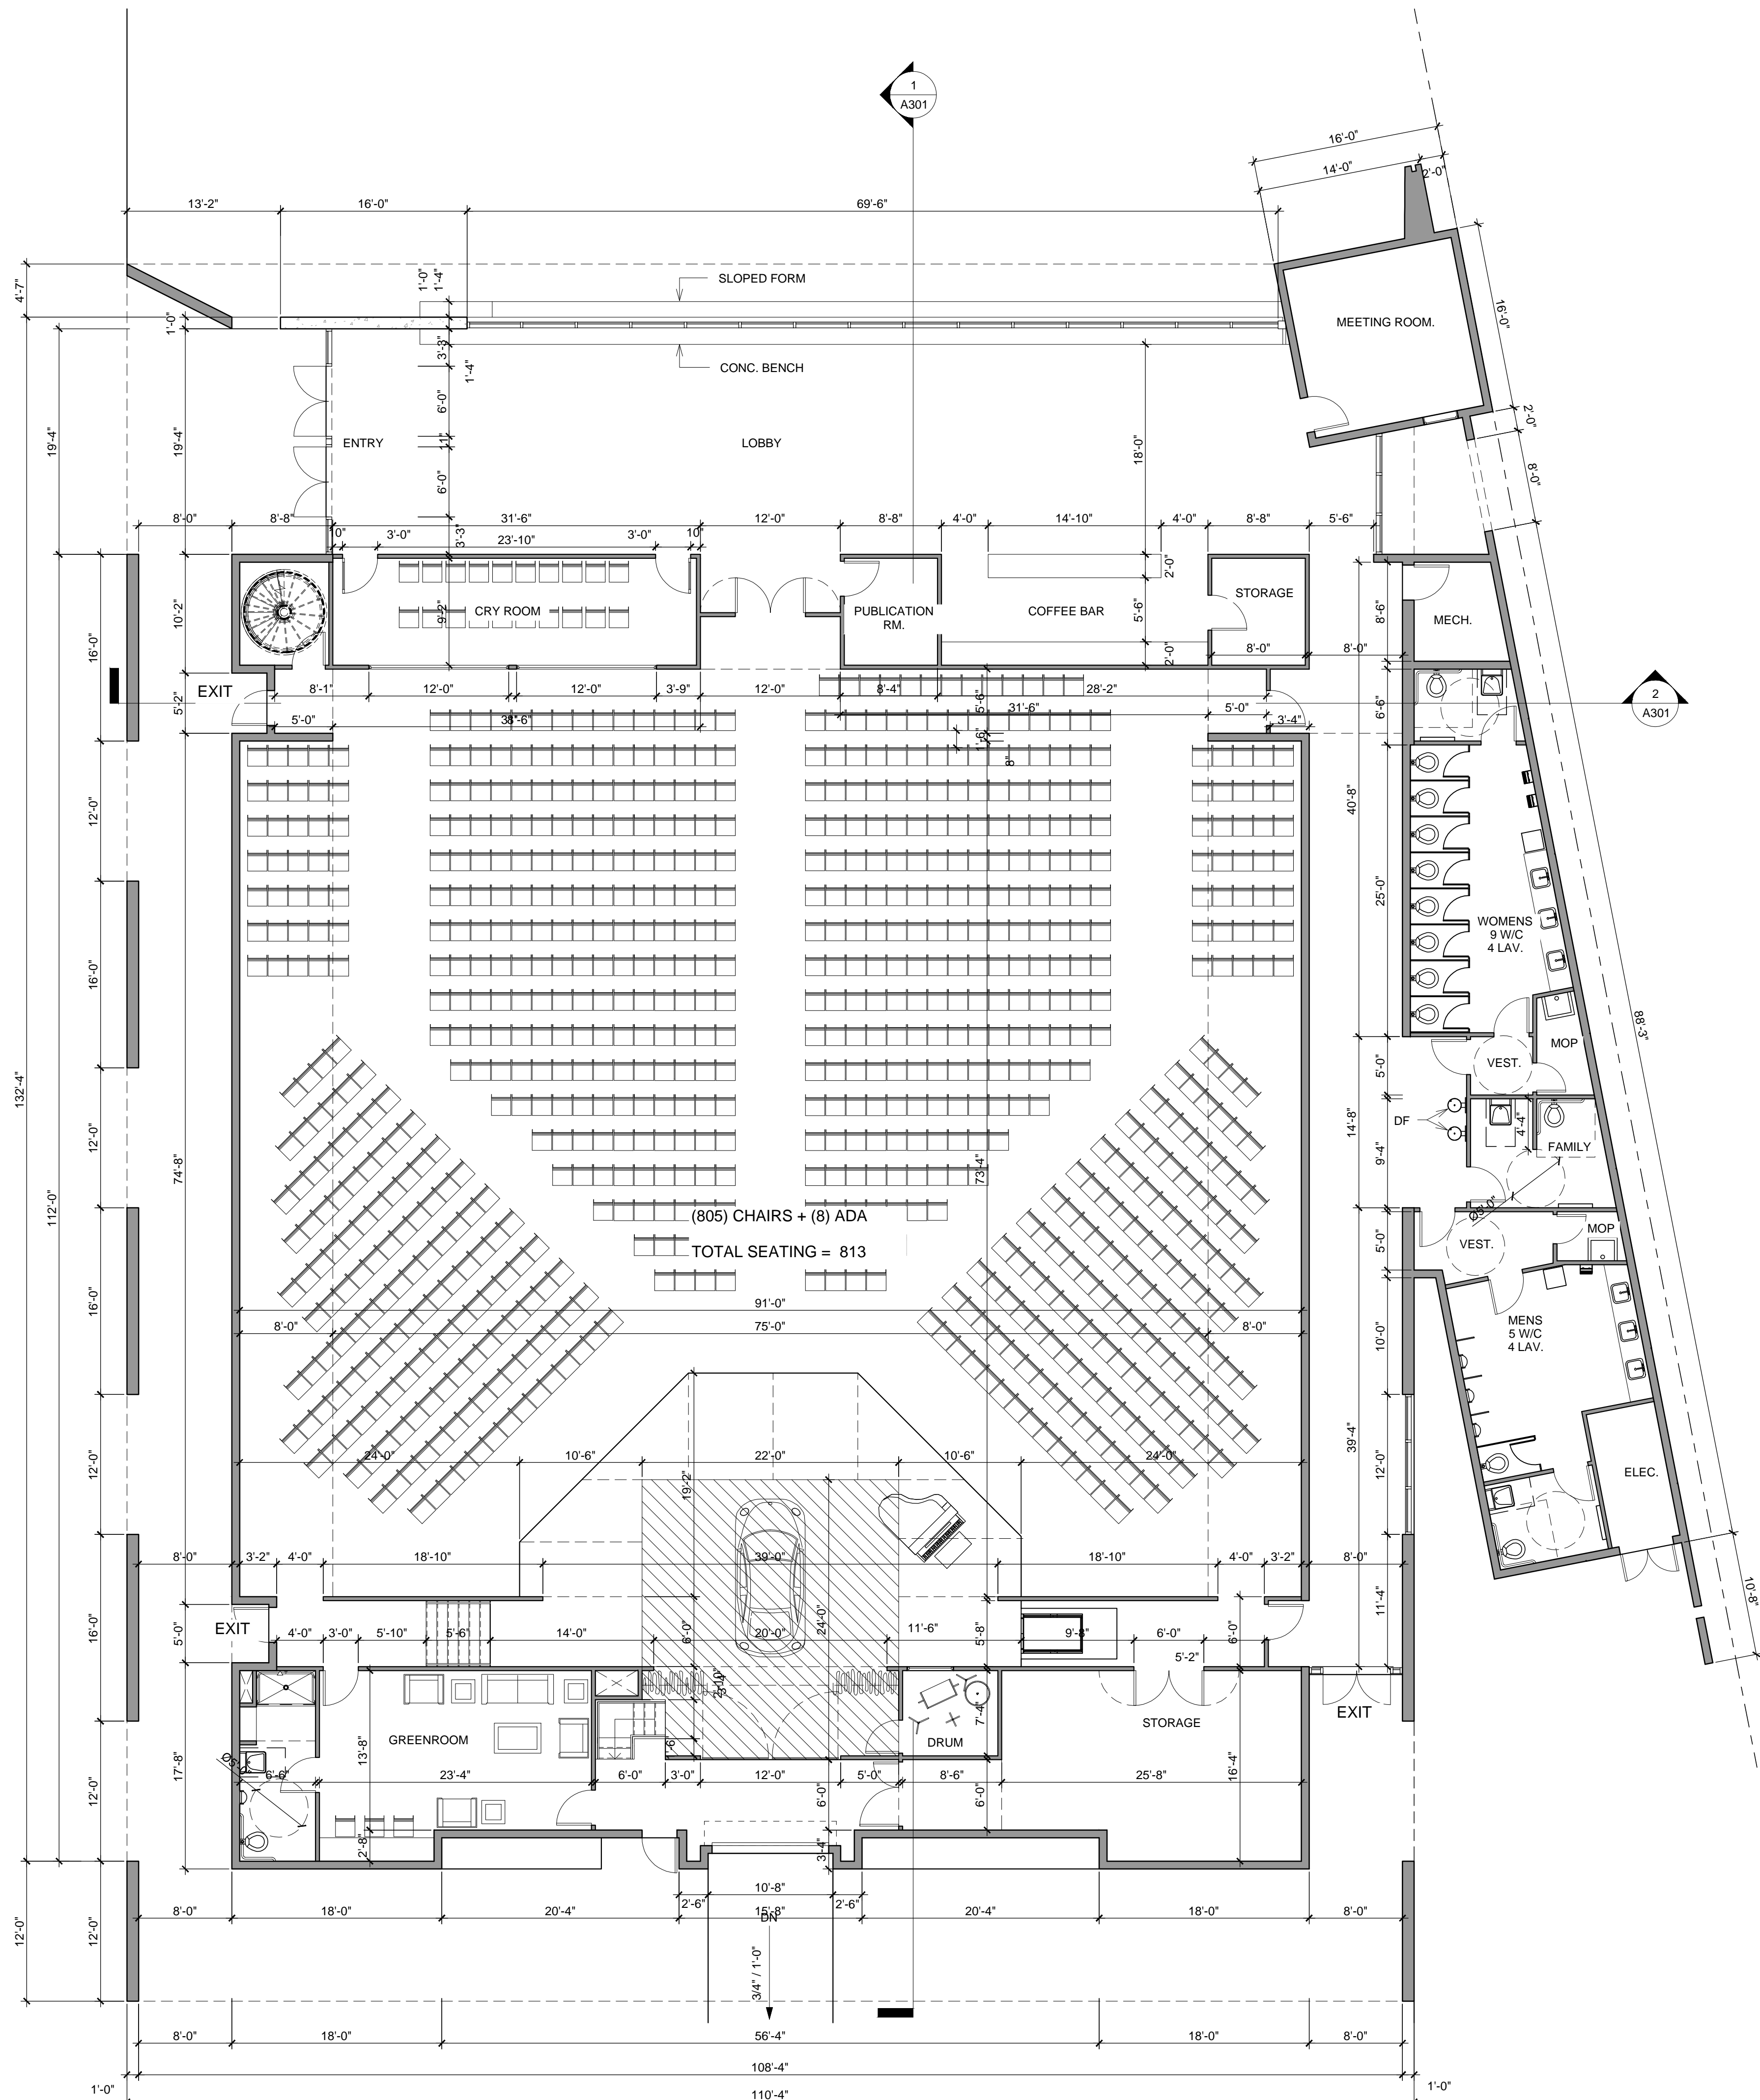

GROUND FLOOR

SCALE: 1/8" = 1'-0"

ELEVATE CHURCH
6250 MIAMI LAKES DR.
MIAMI LAKES, FL 33014

| | |
|--|--|
| | |
| | |
| △ | DATE | REVISION |
|---|------|----------|
|---|------|----------|

DWG. TITLE

2ND FLOOR PLAN
SANCTUARY

SCALE

1/8" = 1'-0"

PROJECT NO.


2014-30

DATE


03-14-17

SHEET NUMBER


A-102

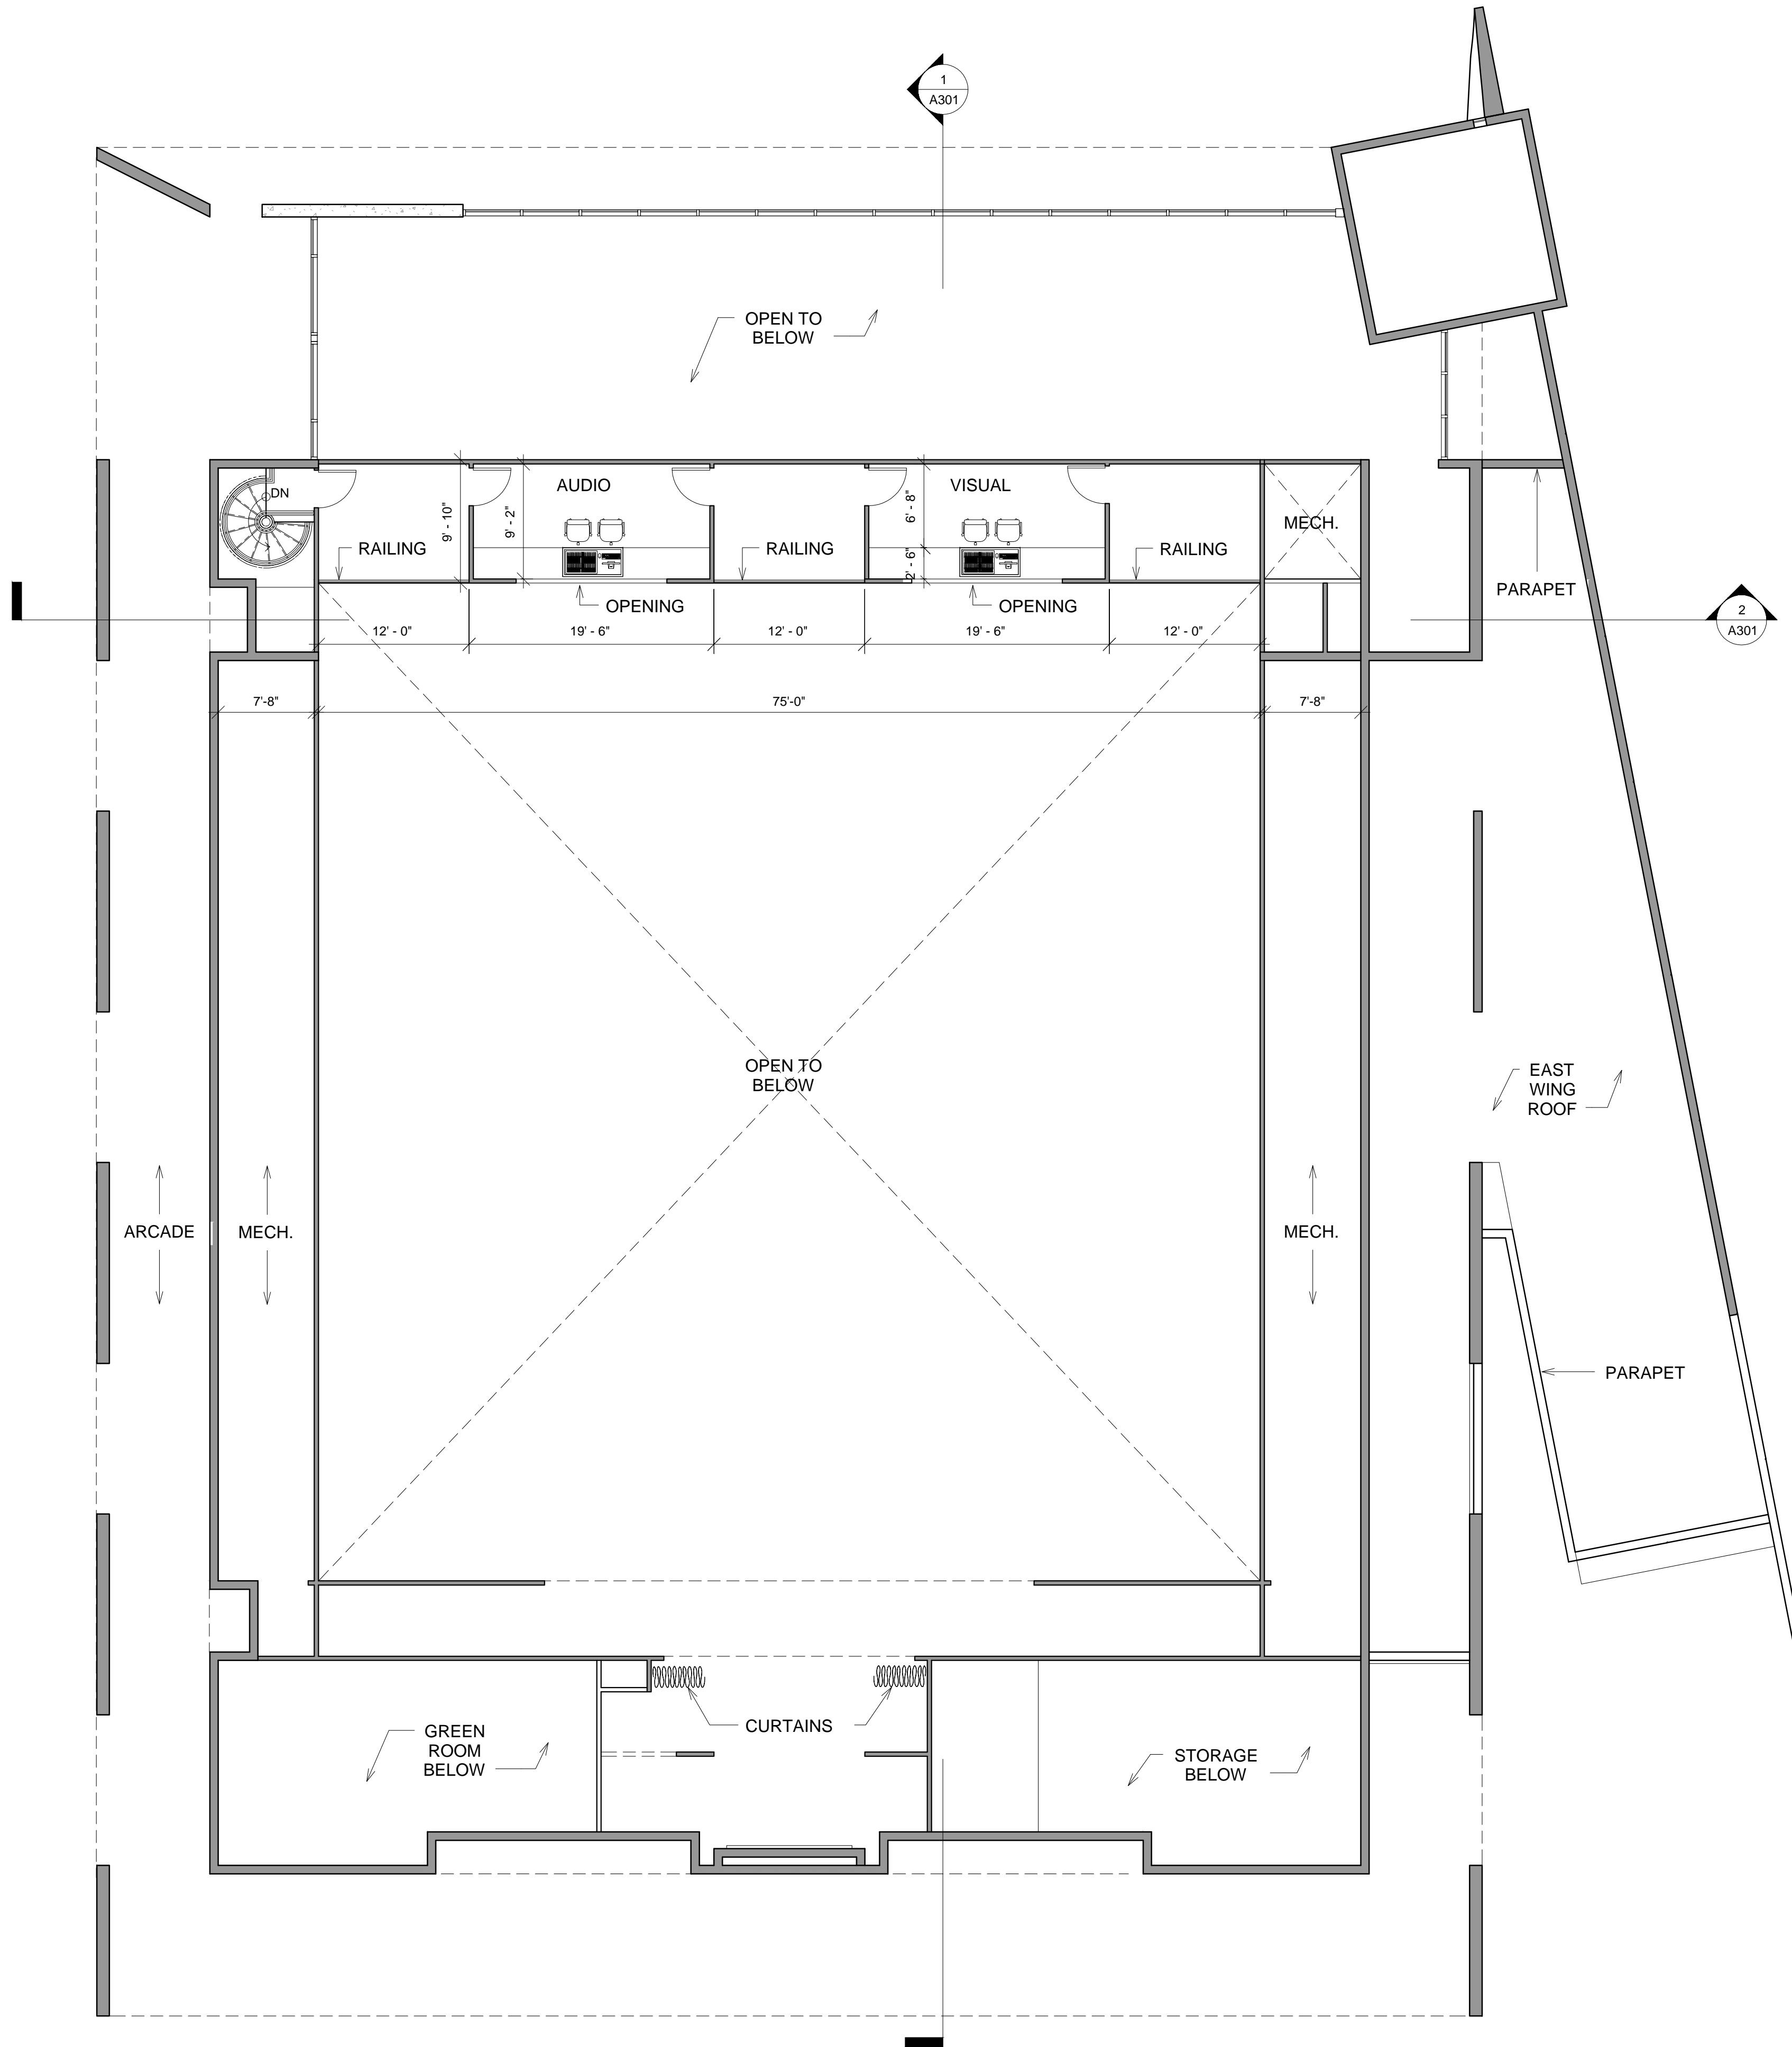

2ND FLOOR PLAN
SCALE: 1/8" = 1'-0"

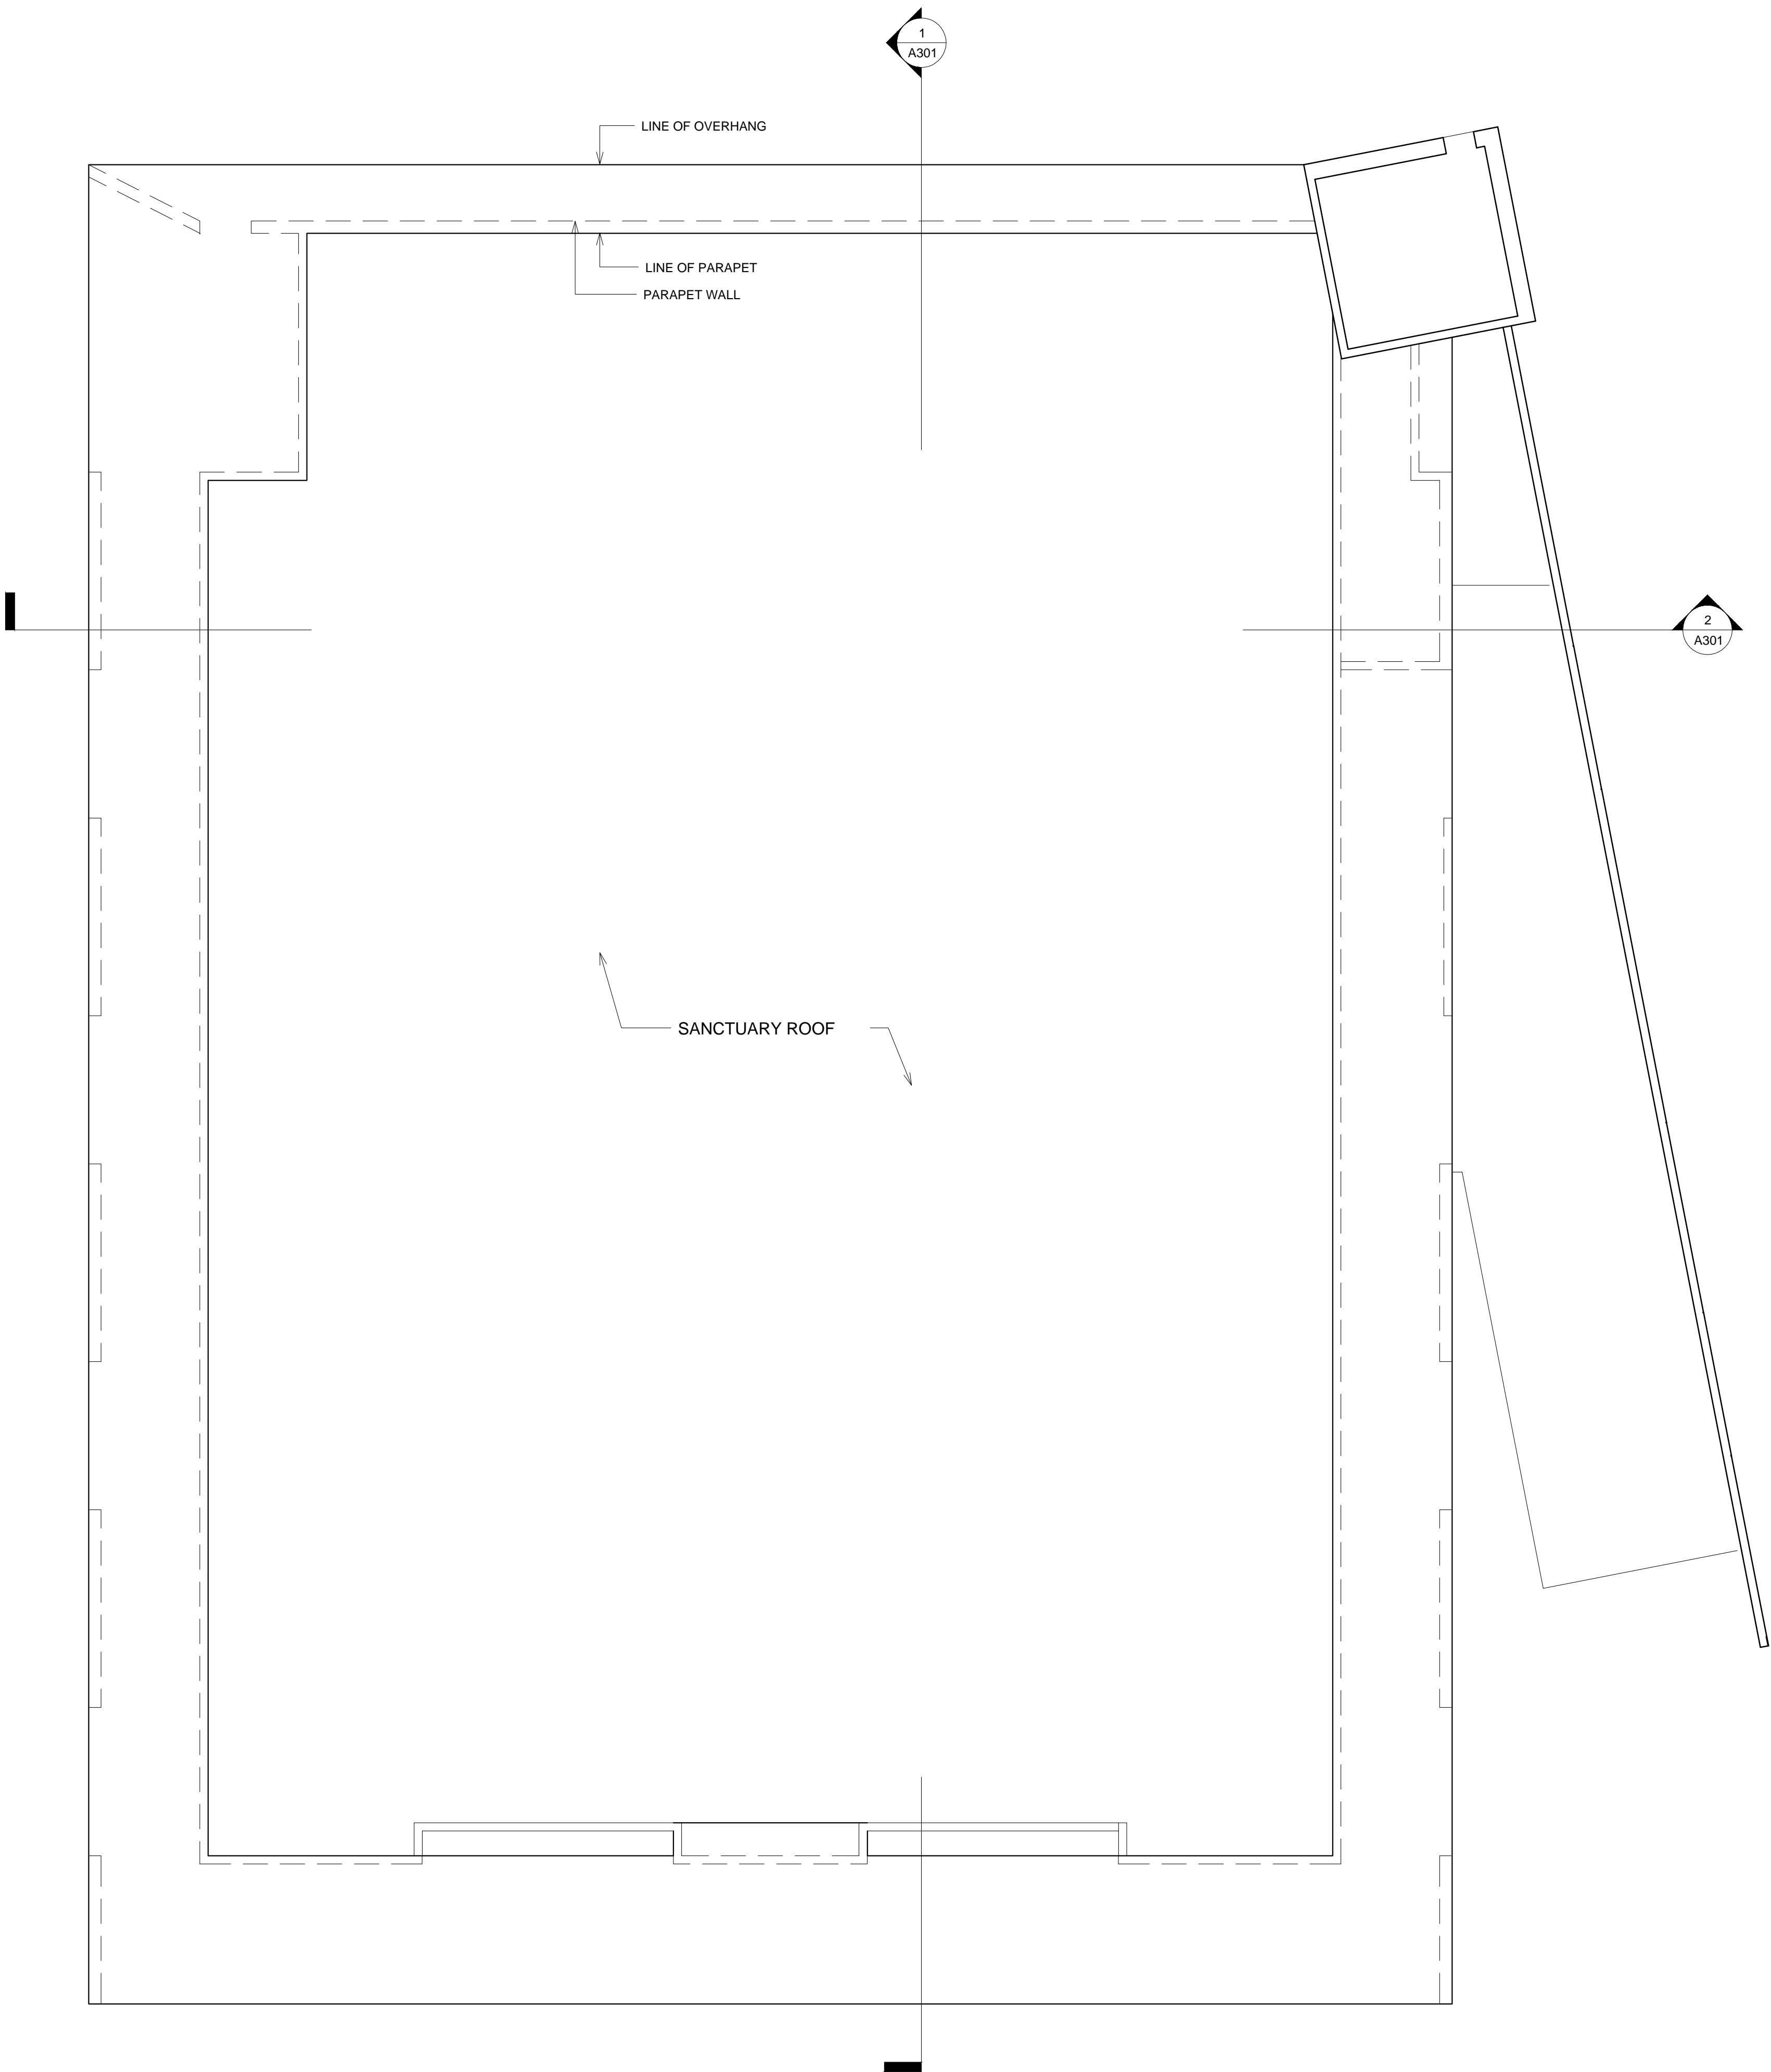

ROOF PLAN
SCALE: 1/8" = 1'-0"

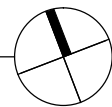

| | |
|--|--|
| | |
| | |
| △ | DATE | REVISION |
|---|------|----------|
|---|------|----------|

DWG. TITLE

ROOF PLAN

SCALE

1/8"=1'-0"

PROJECT NO.

2014-30

DATE

03-14-17

SHEET NUMBER

A-103

ELEVATE CHURCH


6250 MIAMI LAKES DR.
MIAMI LAKES, FL. 33014

BEILINSON
GOMEZ


ARCHITECTS *pa*

ARCHITECTURE AAC001062
JOSE L. GOMEZ AR0015416
8101 BISCAYNE BLVD.
SUITE 309
MIAMI FL 33138-4664
TEL. (305) 559.1250
FAX (305) 551.1740
bellinsonarchitectspa.com

COPYRIGHT 2014. ALL RIGHTS RESERVED. THESE DRAWINGS AND DOCUMENTS ARE INSTRUMENTS OF SERVICE. BELINSON GOMEZ ARCHITECTS P.A. WARRANTS THE PROJECT FOR WHICH THEY WERE PREPARED BE EXECUTED OR NOT, THEY ARE NOT TO BE USED IN ANY MANNER, ON OTHER PROJECTS OR EXTENDED TO THIS PROJECT WITHOUT THE WRITTEN CONSENT OF BELINSON GOMEZ ARCHITECTS P.A. BELINSON GOMEZ ARCHITECTS P.A. IS PROHIBITED CONTRACTORS RESPONSIBLE FOR VERIFYING ALL LIFE CONDITIONS PRIOR TO PROCEEDING WITH WORK.

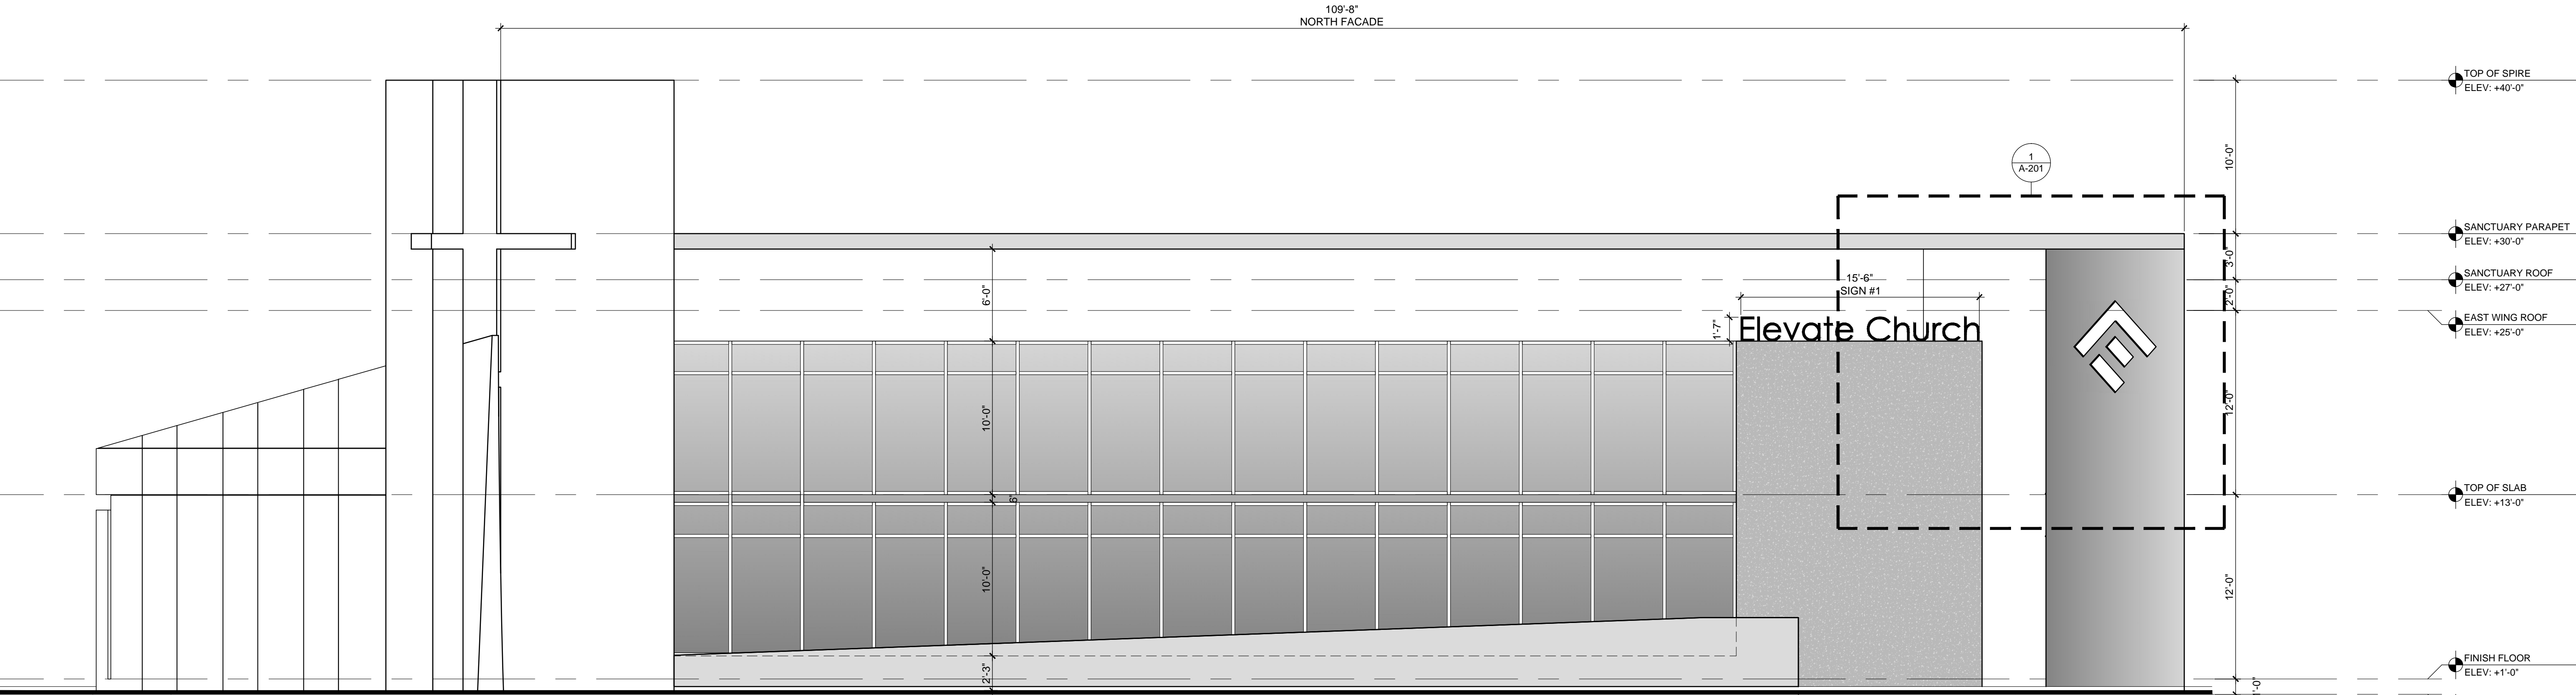


NORTH ELEVATION
SCALE: 3/16"=1'-0"


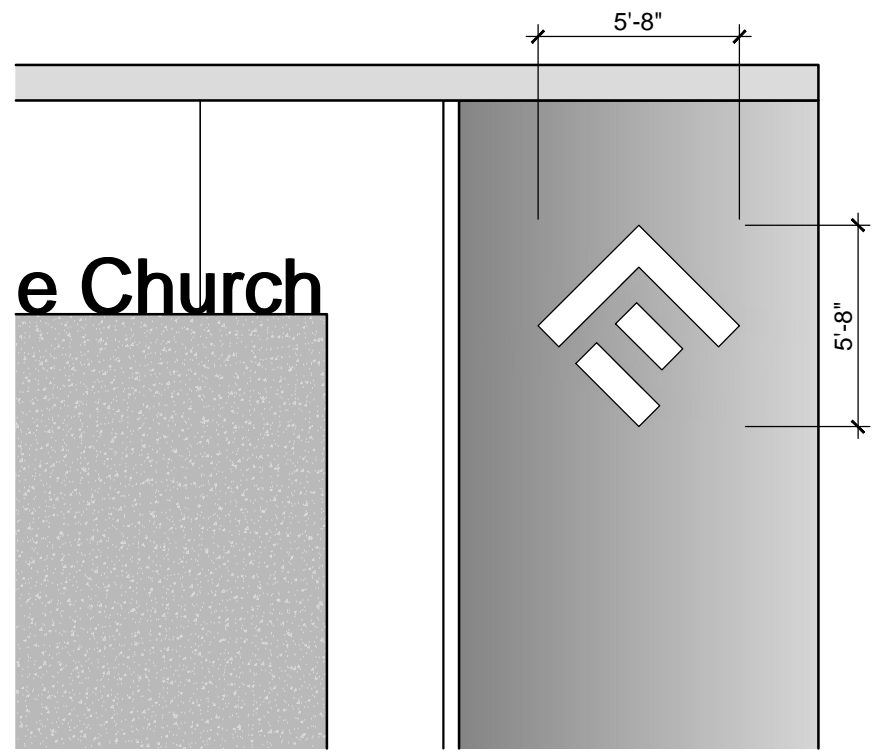


SIGN # 2 @ NORTH ELEVATION
SCALE: 3/16"=1'-0"

| | |
|------------------|-----------------------------------|
| SIGNAGE | |
| NORTH FACE AREA: | 3,384.6 S.F |
| SIGN # 1: | 24.0 S.F |
| SIGN #2: | 32.0 S.F |
| TOTAL: | 56.0 S.F (1.65 % OF NOTRH FACADE) |

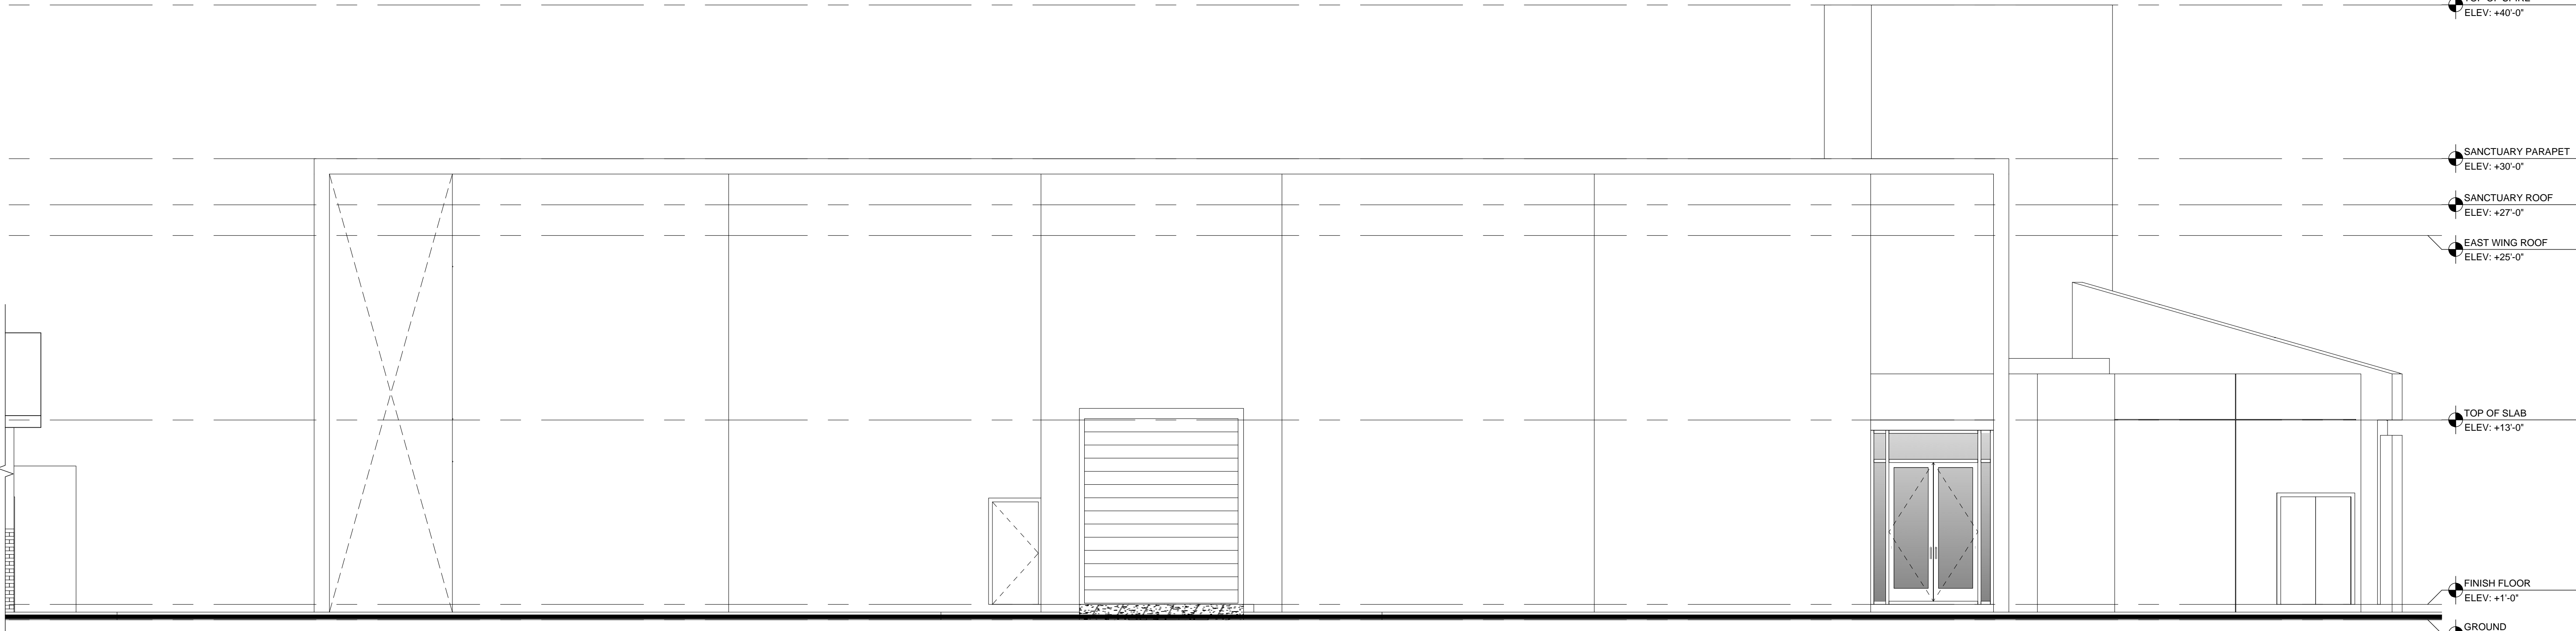

SOUTH ELEVATION
SCALE: 3/16"=1'-0"

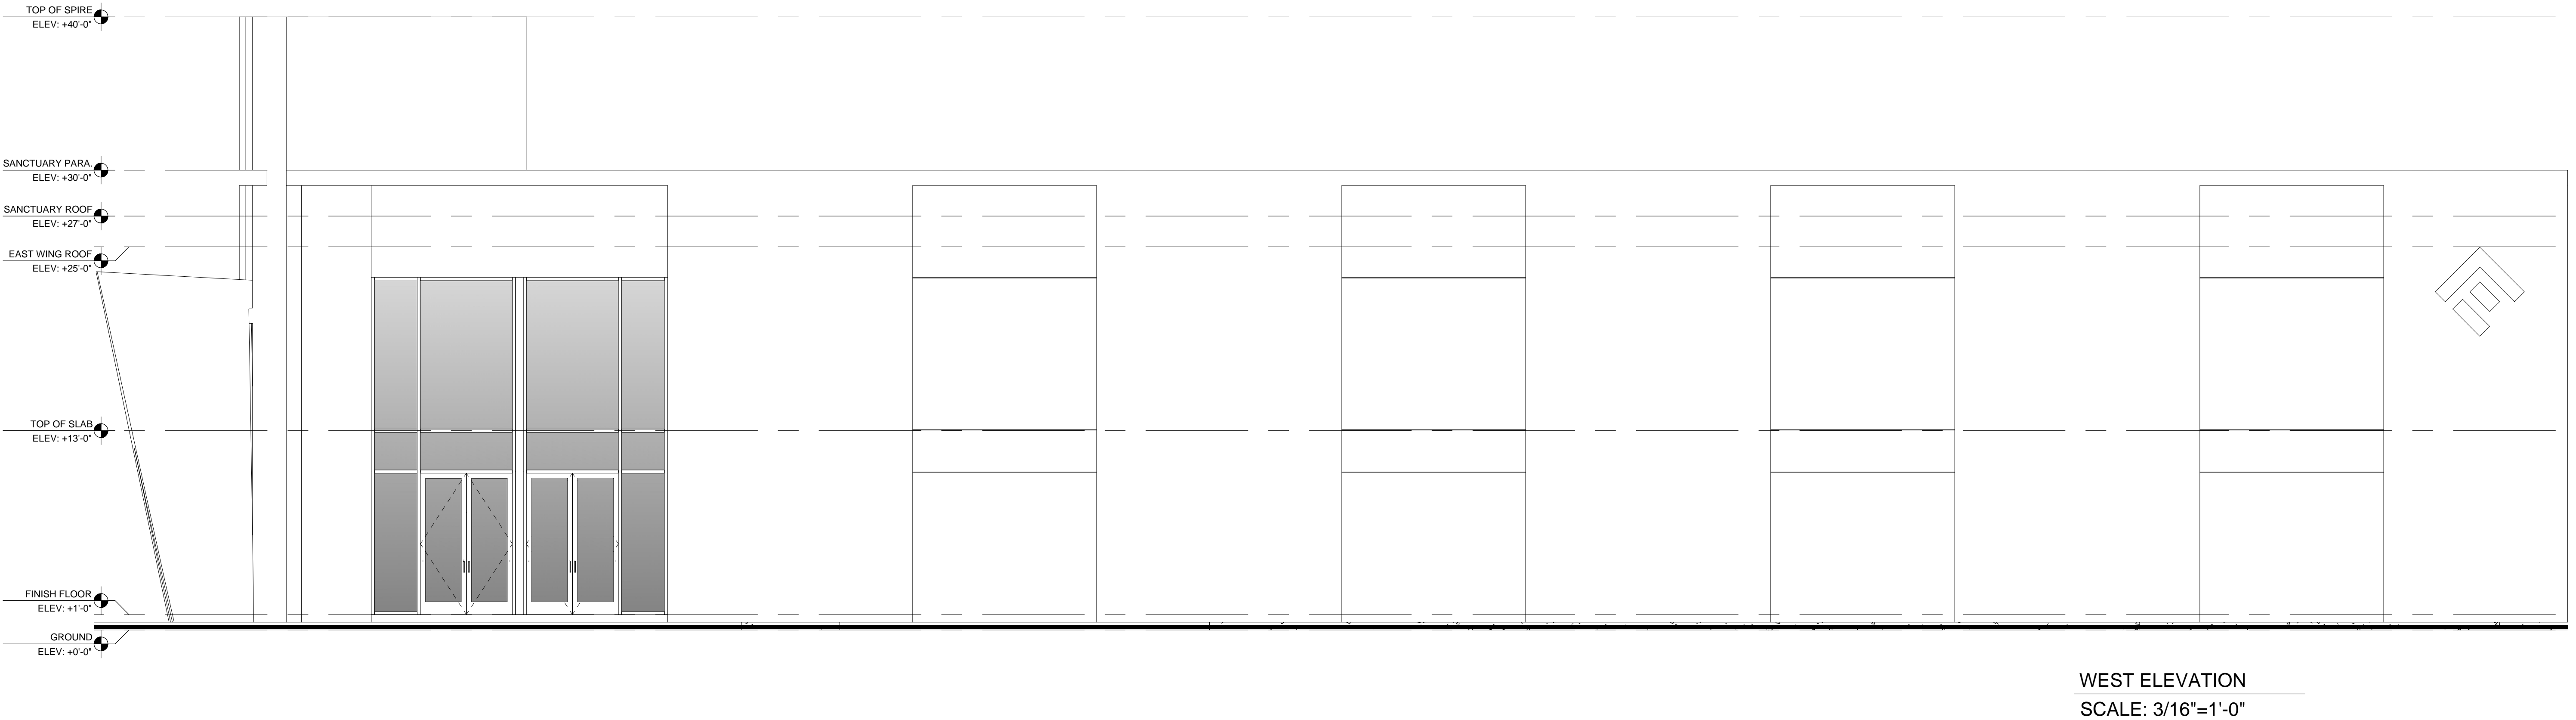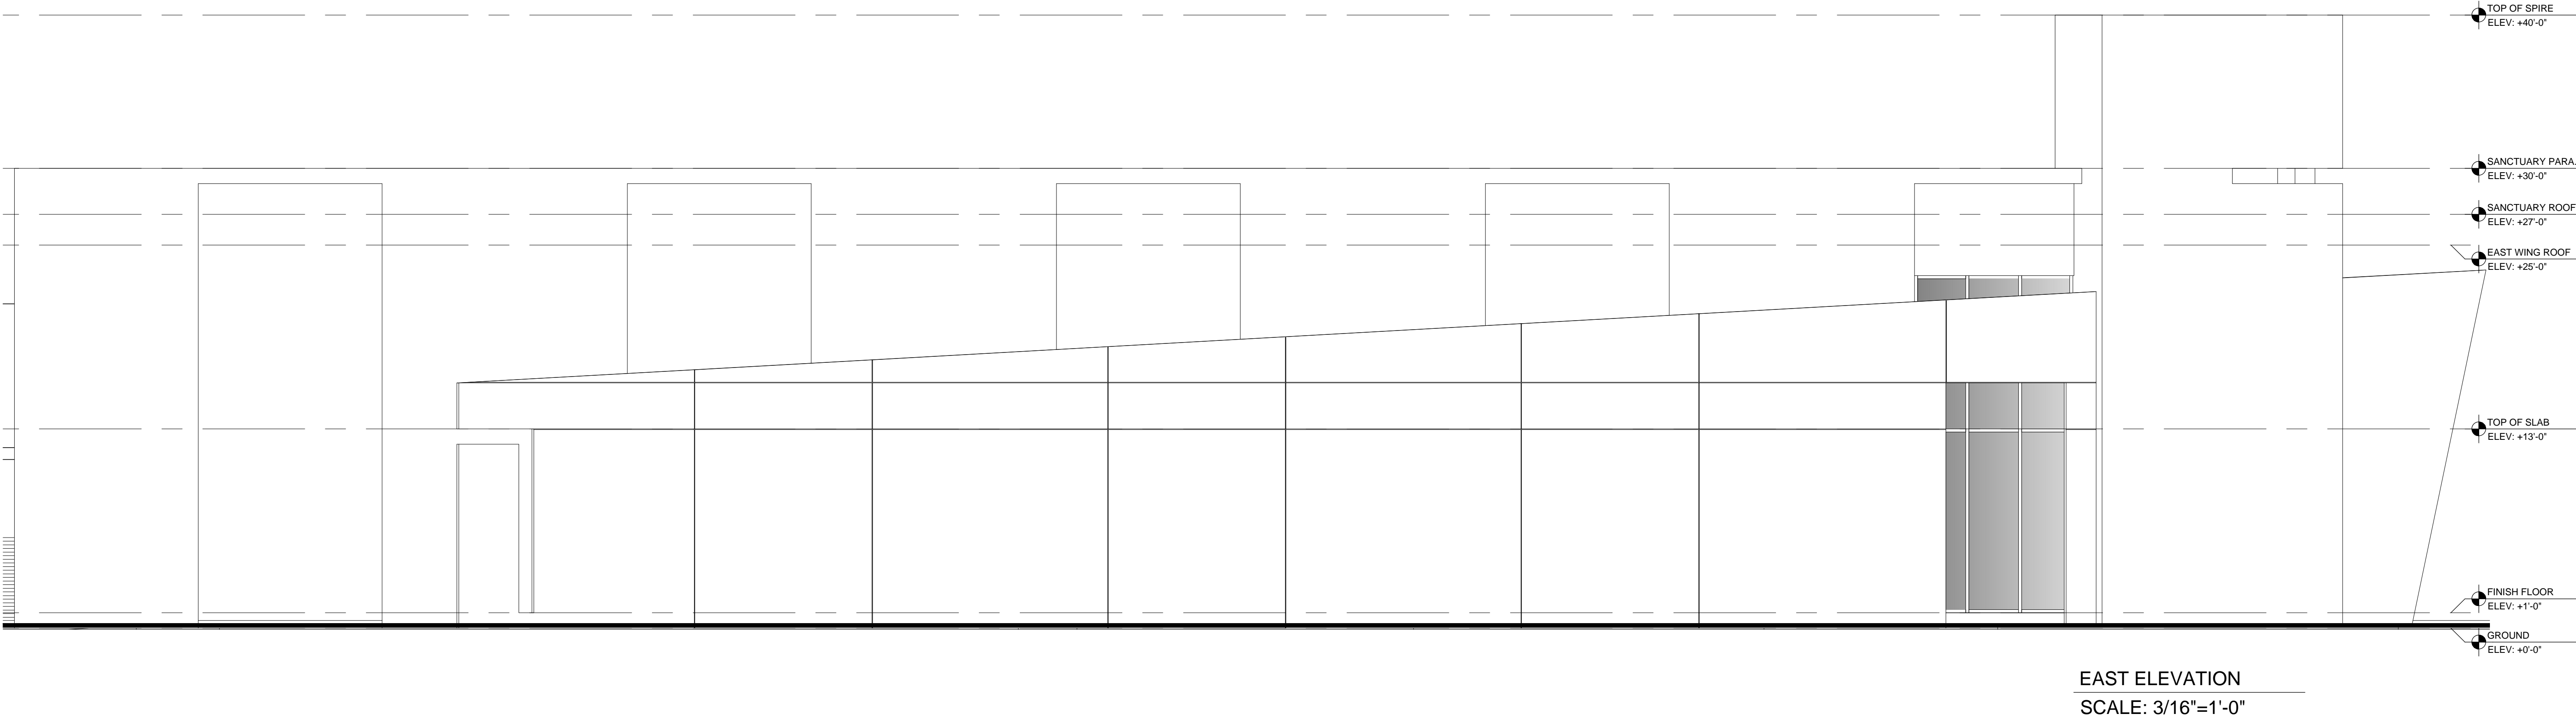

| | |
|--|--|
| | |
| | |
| △ | DATE | REVISION |
|---|------|----------|
|---|------|----------|

DWG. TITLE

EAST & WEST
ELEVATION

SCALE

3/16"=1'-0"

PROJECT NO.



2014-30

DATE

03-14-17

SHEET NUMBER


A-202

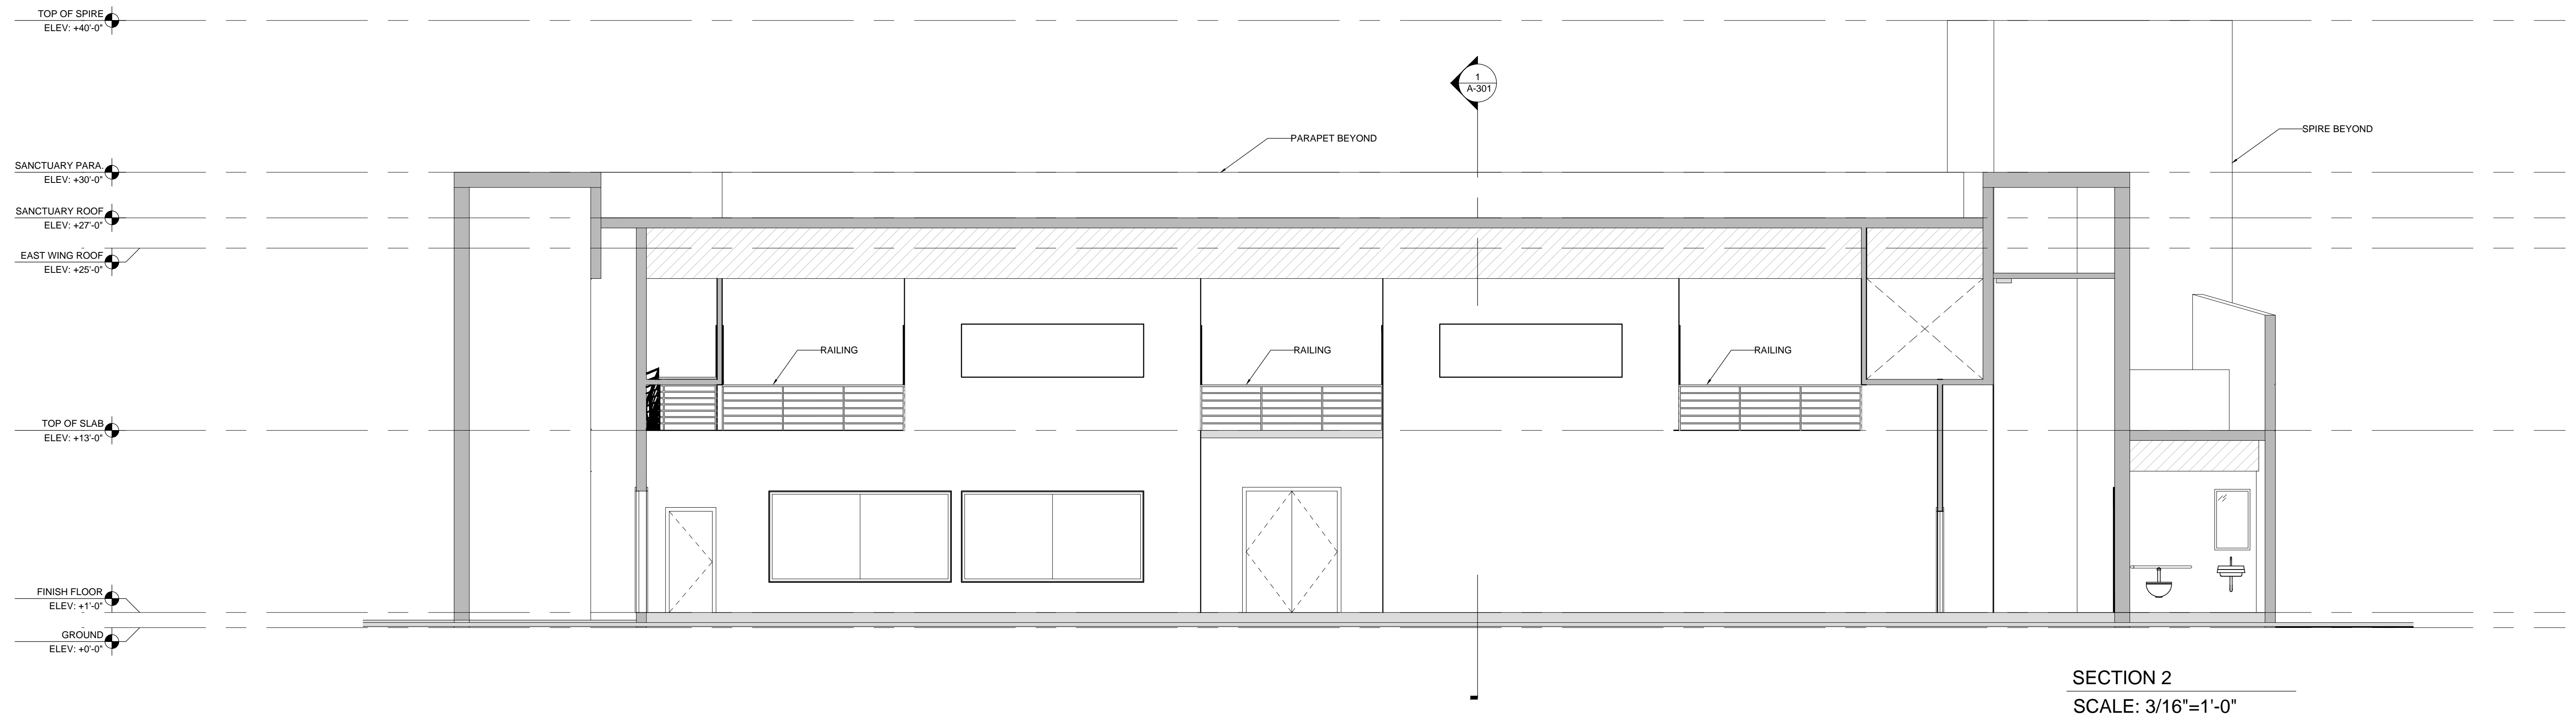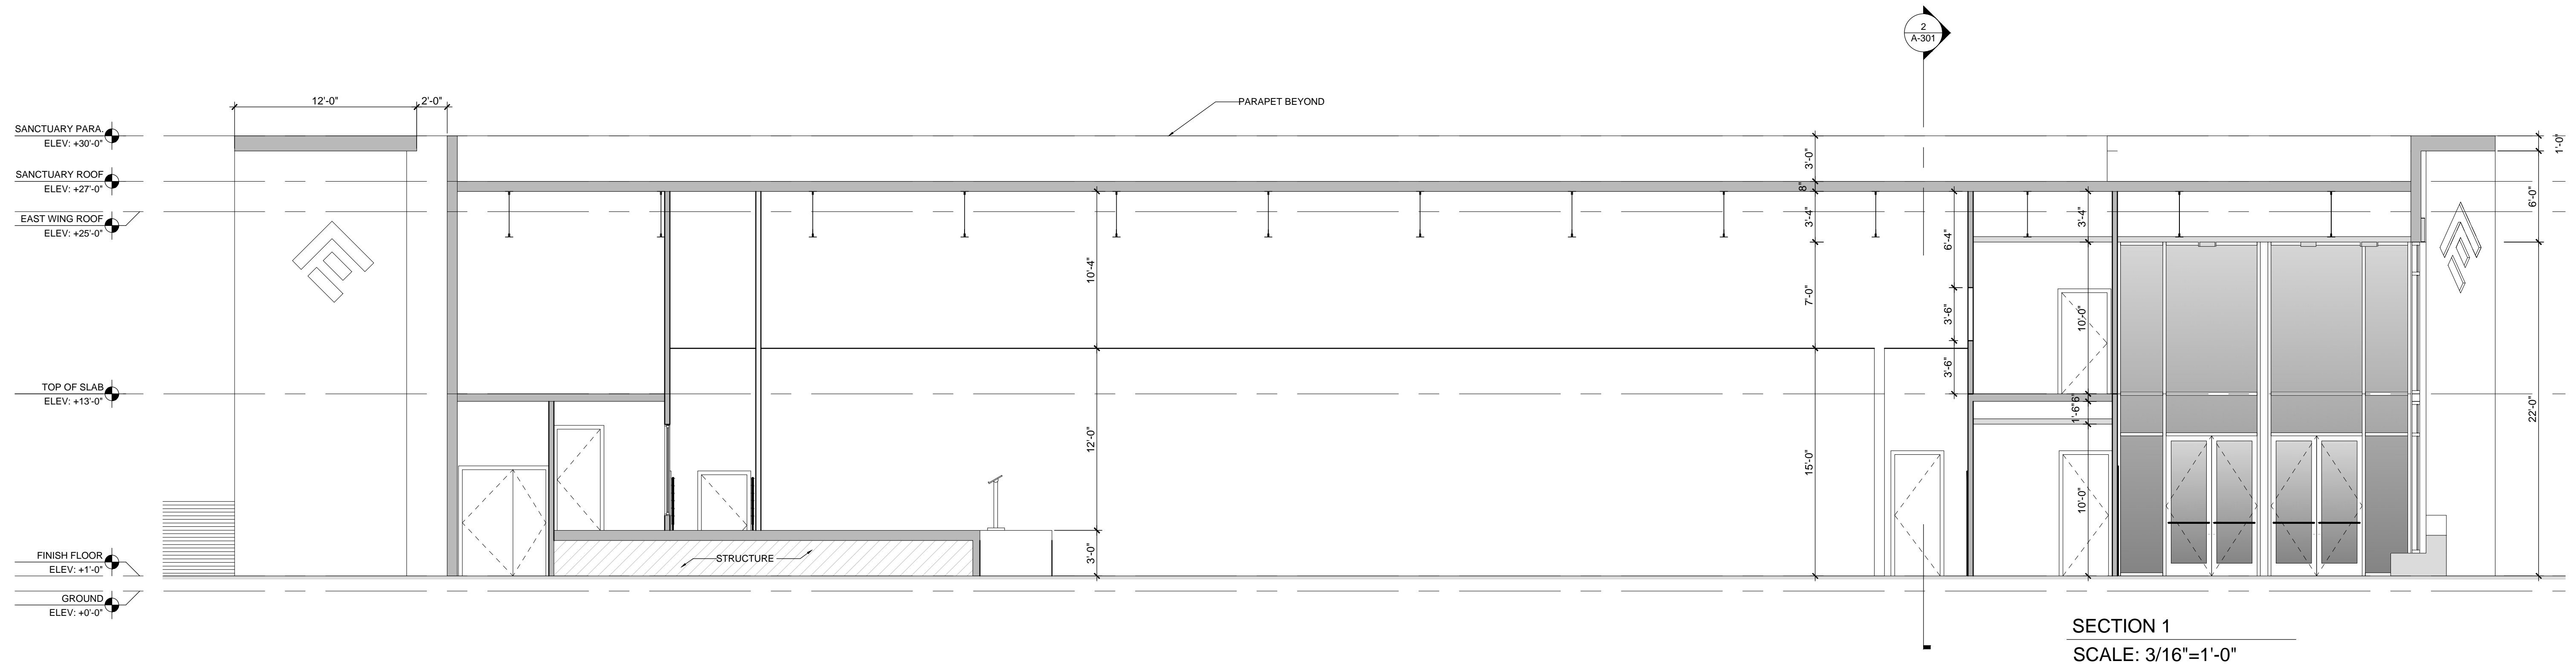

ELEVATE CHURCH
6250 MIAMI LAKES DR.
MIAMI LAKES, FL. 33014

[illegible]

| EXISTING TREE DISPOSITION LIST | | | | | | | |
|--|--------------------------|-------------------------|-----------|------------------------------|-------------|------------|---------------------|
| KEY | BOTANICAL NAME | COMMON NAME | HT. (ft.) | SIZE (SPD. (ft.) DBH. (in.)) | DISPOSITION | MITIGATION | |
| 1 | Swietenia mahagoni | Mahogany | 28 | 32 29.5 | X | | |
| 2 | Swietenia mahagoni | Mahogany | 26 | 30 11 | X | X | 707 |
| 3 | Swietenia mahagoni | Mahogany | 28 | 50 23 | X | X | |
| 4 | Swietenia mahagoni | Mahogany | 45 | 60 36.5 | X | | |
| 5 | Bucida buceras | Black Olive | 35 | 45 17 | | X | 1590 |
| 6 | Swietenia mahagoni | Mahogany | 25 | 38 30 | X | | |
| 7 | Swietenia mahagoni | Mahogany | 34 | 44 35 | X | | |
| 8 | Bucida buceras | Black Olive | 28 | 26 23 | | X | 1062 |
| 9 | Quercus virginiana | Live Oak | 28 | 34 16.5 | X | | |
| 10 | Quercus virginiana | Live Oak | 28 | 34 19 | X | | |
| 11 | Quercus virginiana | Live Oak | 28 | 34 16.5 | X | | |
| 12 | Quercus virginiana | Live Oak | 28 | 34 16 | X | | |
| 13 | Quercus virginiana | Live Oak | 28 | 34 13 | X | X | 908 |
| 14 | Quercus virginiana | Live Oak | 28 | 34 16.5 | X | | |
| 15 | Quercus virginiana | Live Oak | 28 | 18 6 | X | X | 254 |
| 16 | Bucida buceras | Black Olive | 24 | 20 7 | | X | 314 |
| 17 | Quercus virginiana | Live Oak | 26 | 22 11 | | X | 380 |
| 18 | Quercus virginiana | Live Oak | 28 | 22 18 | | X | 760 |
| 19 | Quercus virginiana | Live Oak | 28 | 26 14.5 | | X | 531 |
| 20 | Quercus virginiana | Live Oak | 30 | 20 6.5 | | X | 314 |
| 21 | Bucida buceras | Black Olive | 32 | 28 14 | X | | |
| 22 | Hyophorbe lagunculalis | Bottle Palm | 7 | 5 9 | X | | |
| 23 | Hyophorbe lagunculalis | Bottle Palm | 4 | 5 10 | X | | |
| 24 | Hyophorbe lagunculalis | Bottle Palm | 4 | 5 8.5 | X | | |
| 25 | Phoenix canariensis | Canary Island Date Palm | 7 | 5 10 | X | | |
| 26 | Phoenix canariensis | Canary Island Date Palm | 7 | 5 10 | X | | |
| 27 | Spathoglottis ranzaniana | Queen Palm | 18 | 9 8 | | X | 64 |
| 28 | Schefflera arboricola | Umbrella Tree | 18 | 8 11 | | X | Exempt by ordinance |
| 29 | Phoenix canariensis | Canary Island Date Palm | 5 | 6 10 | X | | |
| 30 | Hyophorbe lagunculalis | Bottle Palm | 6 | 5 12 | X | | |
| 31 | Hyophorbe lagunculalis | Bottle Palm | 7 | 5 12 | X | | |
| 32 | Phoenix canariensis | Canary Island Date Palm | 7 | 5 12 | X | | |
| 33 | Unknown | | 28 | 28 16.5 | X | | |
| 34 | Bucida buceras | Black Olive | 28 | 40 20.5 | X | | |
| 35 | Hyophorbe lagunculalis | Bottle Palm | 10 | 8 15 | | | X |
| 36 | Washingtonia robusta | Mexican Fan Palm | 9 | 10 11 | | X | |
| 37 | Hyophorbe lagunculalis | Bottle Palm | 10 | 8 12 | | | X |
| 38 | Hyophorbe lagunculalis | Bottle Palm | 9 | 8 13 | | | X |
| 39 | Washingtonia robusta | Mexican Fan Palm | 14 | 10 10 | | X | 79 |
| 40 | Washingtonia robusta | Mexican Fan Palm | 12 | 10 10 | | X | 79 |
| 41 | Hyophorbe lagunculalis | Bottle Palm | 9 | 7 10 | | | X |
| 42 | Bucida buceras | Black Olive | 24 | 24 9 | X | | |
| 43 | Bucida buceras | Black Olive | 30 | 42 22.5 | X | | |
| 44 | Vetelia montgomeryana | Montgomery Palm | 12 | 6 5 | X | | |
| 45 | Vetelia montgomeryana | Montgomery Palm | 10 | 6 5 | X | | |
| 46 | Dypsis lutescens | Arecia Palm | 12 | 6 5 | X | | |
| 47 | Dypsis lutescens | Arecia Palm | 12 | 6 5 | X | | |
| 48 | Dypsis lutescens | Arecia Palm | 12 | 6 5 | X | | |
| 49 | Dypsis lutescens | Arecia Palm | 12 | 6 5 | X | | |
| 50 | Dypsis lutescens | Arecia Palm | 14 | 6 5 | X | | |
| 51 | Dypsis lutescens | Arecia Palm | 14 | 6 5 | X | | |
| 52 | Dypsis lutescens | Arecia Palm | 14 | 6 5 | X | | |
| 53 | Dypsis lutescens | Arecia Palm | 14 | 6 5 | X | | |
| 54 | Dypsis lutescens | Arecia Palm | 14 | 6 5 | X | | |
| 55 | Bucida buceras | Black Olive | 22 | 38 15.5 | X | | |
| 56 | Bucida buceras | Black Olive | 20 | 15 11 | X | | |
| 57 | Quercus virginiana | Live Oak | 16 | 20 7 | X | | |
| 58 | Quercus virginiana | Live Oak | 16 | 20 8 | X | | |
| 59 | Quercus virginiana | Live Oak | 16 | 20 9 | X | | |
| 60 | Quercus virginiana | Live Oak | 11 | 8 6 | X | | |
| 61 | Bucida buceras | Black Olive | 25 | 38 23 | X | | |
| 62 | Bucida buceras | Black Olive | 25 | 29 15 | X | | |
| 63 | Sabal palmetto | Sabal Palm | 18 | 10 10 | X | | |
| 64 | Bucida buceras | Black Olive | 30 | 40 19.5 | X | | |
| 65 | Bucida buceras | Black Olive | 28 | 38 18 | X | | |
| 66 | Bucida buceras | Black Olive | 26 | 38 18.5 | X | | |
| 67 | Sabal palmetto | Sabal Palm | 16 | 5 9 | X | | |
| 68 | Quercus virginiana | Live Oak | 24 | 30 17 | X | | |
| 69 | Quercus virginiana | Live Oak | 24 | 28 13.5 | X | | |
| 70 | Quercus virginiana | Live Oak | 24 | 28 13 | X | | |
| 71 | Quercus virginiana | Live Oak | 24 | 20 10 | X | | |
| 72 | Quercus virginiana | Live Oak | 25 | 33 20 | X | | |
| 73 | Quercus virginiana | Live Oak | 25 | 28 10 | X | | |
| 74 | Quercus virginiana | Live Oak | 24 | 30 15 | X | | |
| 75 | Quercus virginiana | Live Oak | 28 | 34 19 | X | | |
| 76 | Quercus virginiana | Live Oak | 28 | 34 16.5 | X | | |
| TOTAL CANOPY S.F. TO BE REPLACED | | | | | | | 6,335 |
| TOTAL CANOPY S.F. MITIGATION PROVIDED | | | | | | | 41,300 |
| DENOTES SPECIMEN TREES TO BE REMOVED (TREE CANOPY DOUBLED) | | | | | | | |

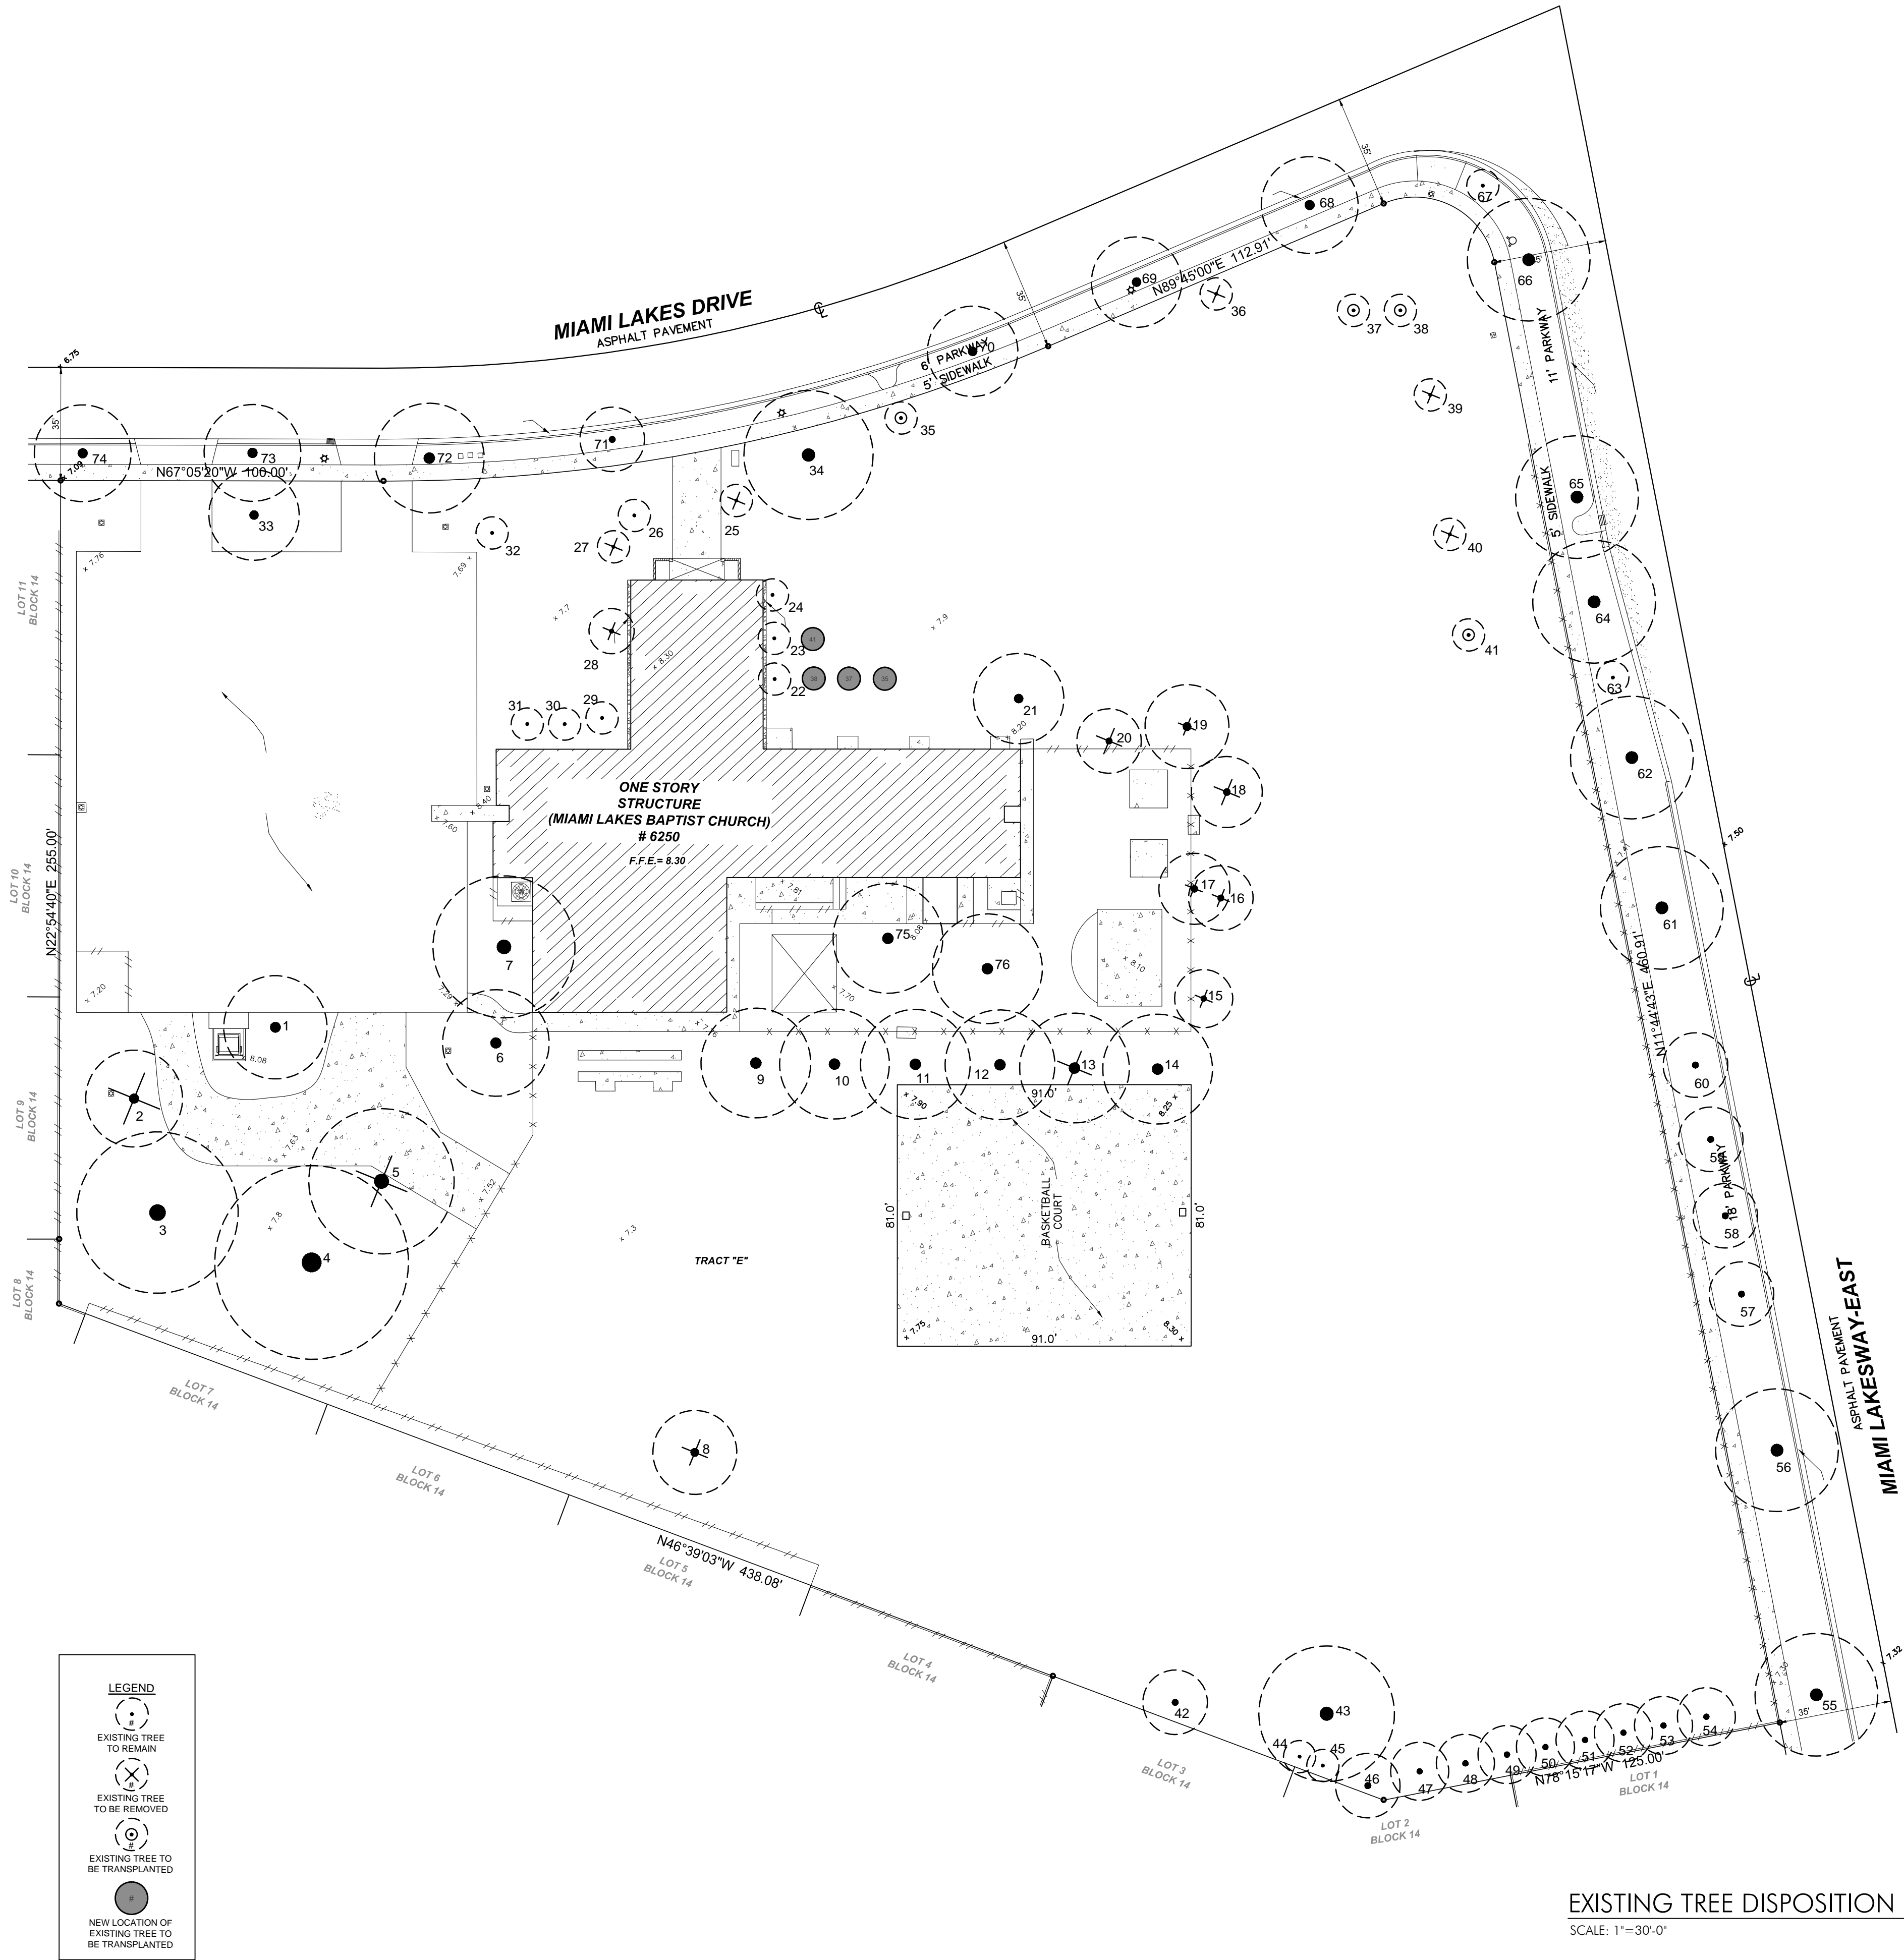


EXISTING TREE DISPOSITION PLAN
SCALE: 1"=30'-0"

This drawing is the property of GSLA Design and is not to be reproduced or copied in whole or part without written permission. It is not to be used on any other project and is to be returned on request. Contractor is responsible for verifying all site conditions prior to proceeding with work.
COPYRIGHT © 2017

ELEVATE CHURCH
6215 Miami Lakes Drive
Miami Lakes, FL 33014

| | |
|-------|--------------------------------|
| REV. | |
| TITLE | EXISTING TREE DISPOSITION PLAN |
| DATE | 03.14.17 |
| SCALE | as noted |
| SHEET | LA-1 |

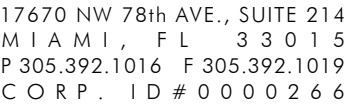

This drawing is the property of GS&L Design and is not to be reproduced or copied in whole or part without written permission. It is not to be used on any other project and is to be returned on request. Contractor is responsible for verifying all site conditions prior to proceeding with work.

C O P Y R I G H T © 2 0 1 7

ELEVATE CHURCH
6215 Miami Lakes Drive
Miami Lakes, FL 33014

[illegible]

TITLE

TRANSPLANTING
SPECS & TREE
PROTECTION
DETAIL



SCALE as noted

SHEET LA-2

1.01 Root Pruning, Watering Before Transplanting

A Prior to root pruning and before excavating holes for transplanted trees, check with all local utilities to locate existing utilities. If any unknown utilities or sprinkler pipes are in a potentially broken, do not cover them up. Immediately notify the utility and/or the Client, and take all necessary steps to repair the break.

B Root prune trees a minimum of eight (8) weeks prior to moving them. It is not necessary to root prune palms prior to transplanting unless specifically instructed to do so by the Landscape Architect. Prior to root pruning,

C Root pruning shall be accomplished by digging a trench two-thirds (2/3) of the way around the tree at a minimum of twenty four (24) inches deep. Root prune only with a mechanical root-pruning saw or a trencher with a trenching shield wider than 48 inches. The trench shall be filled with a rootball of the minimum following sizes:

| | |
|------------------|---------------|
| Up to 5" caliper | 5 diameter |
| 6"-8" caliper | 6-7 diameter |
| 9"-12" caliper | 9-10 diameter |
| Over 12" caliper | 12 diameter |

D All exposed roots shall be cut off smoothly, with sharp instruments. Backfill trenches with soil consisting of 30% silica sand and 70% mulch. Water them thoroughly immediately after root pruning, and once weekly during the root regeneration period for two weeks add a soluble fertilizer that has a 20:20:20 analysis at manufacturer's recommended rate, to the watering schedule.

E It may be necessary to remove curbing and/or paving to complete the root pruning operation. Where this is required, the Contractor shall fill cut adjacent with a concrete slab, any section of curb or pavement before cutting the roots. This material shall be removed from the site by the Contractor and the area of pavement cut and removed by the root pruning shall be filled to flush with adjacent pavement.

A. The amount of general pruning and thinning shall be limited to the minimum necessary to remove dead or injured twigs or branches and to compensate for the loss of roots as a result of transplanting operations. Approximately 1/3 of the mass of the canopy shall be removed unless otherwise instructed by the Landscape Architect. Pruning and thinning shall be done in such a manner as not to change the natural habit or shape of a plant. For very large trees that must be transported on public R.O.W.'s or where obstacles require it, additional pruning may be allowed at time of transport; cut back trees to the maximum size which can be transported after limbs are tied in as much as possible. The Landscape Architect shall be contacted prior to performing any major pruning or thinning.

A Bracing and Guying shall be provided to assure the trees' stability during the root regeneration period, if required by the Landscape Architect.

A. Plant material which is in a soil of a loose texture, which does not readily adhere to the root system, especially in the case of large plants or trees, shall have the rootball wrapped in burlap and then wire, if directed by the Landscape Architect.

- A. Movement of plants on public R.O.W.s shall comply with all ordinances, codes and safety requirements, etc.
- B. Transport materials on vehicles large enough to allow plants to not be crowded and damaged. Plants shall be covered to prevent wind damage during transport.
- C. Protect plant material during transporting to prevent damage to the root system and desiccation of leaves. Trees shall be protected by tying in the branches and covering all exposed branches as necessary. Do not bend or bind/plant material in such a manner as to damage bark, break branches or alter the natural shape.
- D. The contractor shall exercise care in handling, loading, unloading, storing, and transporting material to prevent damage. The contractor shall assume full responsibility for protection and safekeeping of materials stored.
- E. Transplanting must be done within 24 hours after being dug. Store plants in shade and keep the root ball and canopy moist.

A. Excavation of Holes: Plant holes shall be roughly cylindrical in shape with sides approximately vertical. The depth of the hole shall be equal to the rootball depth plus 12" unless further depth is required to provide adequate drainage. The diameter of the hole shall be a minimum of 24" larger than the rootball diameter.

1) PLANT MATERIAL SHALL BE PLANTED AT THEIR NATURAL AND ORIGINAL PLANTING LEVEL PRIOR TO THEIR PLACEMENT ON THIS PROJECT OR JOB. WHEN LOWERED INTO THE HOLE, THE PLANTS SHALL REST ON THE PREPARED HOLE BOTTOM SUCH THAT THE SURFACE ROOTS AT THE TOP OF THE ROOTBALL ARE LEVEL OR SLIGHTLY ABOVE THE HOLE BOTTOM. PLANTS SHALL BE PLANTED AT A SAUCE, APPROXIMATELY 4" DEEP TO HELP HOLD THEM. THE PRACTICE OF TUNING, BURYING OR PLANTING IN PLANT MATERIAL SUCH THAT THE SURFACE ROOTS AT THE TOP OF THE ROOTBALL ARE BELOW THE LEVEL OF THE SURROUNDING FINAL GRADE WILL NOT BE PERMITTED UNLESS IT IS INDICATED OTHERWISE IN THESE SPECIFICATIONS. The plants shall be set straight or plumb or normal to the relationship of their growth prior to transplanting. The Landscape Architect reserves the right to replace any plant material after it has been set.

- 1) Use planting soil consisting of 40% silica sand, 40% muck, and 20% well-rotted compost derived from yard wastes.
- 2) Backfill the bottom two-thirds of the planting hole and firmly tamp and settle by watering as backfilling progresses. After having tamped and settled the bottom two-thirds of the hole, thoroughly puddle with water and fill remaining one-third of the hole with planting soil, tamping and watering to eliminate air pockets.
- 3) Add Diehard® transplant inoculant supplied by Horticultural Alliance, Inc. (800-628-6373) or equal. Mix into top 8-10 inches of planting hole, making sure it is contact with the root ball. Add at a rate of one (1) 8oz. bag per 2 inches of trunk caliper.

A. Once trees have been relocated and well-watered in during the transplanting, provide water for a period of 60 days after transplanting.

| When | Frequency | Amount |
|-----------------|-----------------|-------------|
| first week | once daily | 3" per tree |
| second week | every other day | 2" per tree |
| following month | twice a week | 1" per tree |
| last 2 weeks | once per week | 1" per tree |

C. In addition to the rootball watering, the canopy of the large shade trees (over 12" caliper) shall be watered with an automatic irrigation system spraying the canopy. Spray heads shall be installed near the top of the canopy and spaced so that the entire canopy shall be sprayed. This system shall remain in place until directed by the Landscape Architect to be removed.

D. If there is no source for water available at the project, such as a hose bib(s) or fire hydrant(s) if approved for use, then the Contractor shall be responsible for supplying water by means of a truck or tank. It is the Contractor's responsibility to pay any fees for water use.

A. Spread 3" thick layer of shredded Eucalyptus or Melaleuca mulch over entire area of the rootball

A. At time of watering root-pruned trees prior to transplanting, drench rootball once per week during the course of watering with a soluble fertilizer that has a 20.20.20 analysis at manufacturer's recommended rate.

B. Three (3) weeks after transplanting, and after mulching, apply on the surface, evenly spread over the area of the entire rootball, FEC (Florida East Coast Fertilizer Co) #5231 (12-6-8) or equal at the rate of one (1) pound per inch of trunk diameter.

A. Stake all trees and palms at the new site with new timbers with a minimum 2" x 4" dimension as per the details enclosed, or in the case of obstacle, in another manner which will support the trees.


A. Disposal of Waste: All waste and other objectionable material created through planning operations and landscape construction shall be removed completely on a daily basis from the job or as directed by the Landscape Architect. Any paved areas, including curbs and sidewalks which have been strewn with soil, soil waste, fertilizer or other waste shall be thoroughly swept. The Contractor shall provide adequate facilities for disposal or removal of waste on-site.

B. The Contractor shall remove and dispose of stakes and battens and until any tie-up plants when it is determined by the Landscape Architect that sufficient time has elapsed for the plants to root stabilizing the plant. This shall be done even if the project has been completed and given final acceptance.

C. Backfilling shall be done immediately after tree removal, or suitable backfills shall be provided to prevent injuries. The Contractor shall backfill holes with clean fill to a level flush with adjacent grade.

A. During all transplanting operations, the Contractor is responsible to maintain the safe flow of vehicular and pedestrian traffic around hazardous areas. The Contractor shall provide barricades, cones, signal boards, etc. as necessary to adequately warn traffic and maintain flow of traffic around or through construction zones. Work shall be performed in such a manner that minimizes the amount of time traffic is impeded by construction activities. Coordinate with Landscape Architect.


A Plant material which is on the site and scheduled to be transplanted is not covered by the guarantee, except in the case of Contractor's negligence or work that has been done in an unworkmanlike manner. If it is determined by the Landscape Architect that the Contractor's negligence or unworkmanlike operations has severely damaged or poses a threat to the health of material to be transplanted or already transplanted, then the Contractor shall be required to replace the tree at a size equal to the transplanted tree, at his cost, and water it as per 1.07.

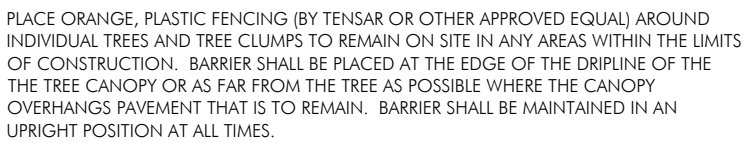

TREE PROTECTION DETAIL

N.T.S.

| TREES | | | | | |
|-------------------------|--|------|--------------------|--|-----------|
| KEY | PLANT NAME | QTY. | UT. | SIZE | |
| *BUSI | Bunsura sinarubus ...Cumbo Limbo ...Silver Buttonwood | 19 | ea. | 12' tall x 5' spread, 2' cal. | |
| *COES | Conocarpus erectus "Sericeus" | 6 | ea. | 8' tall o.d. spread, lifted to tree form, max. 3 trunks | |
| *LYSA | Lysioloma sebicum ...Sabicu Tamarind | 13 | ea. | 12' tall x 5' spread, 2' cal. | |
| *QVVI | Quercus virginiana ...Live Oak | 14 | ea. | 12' tall x 5' spread, 2' cal. | |
| PALMS | | | | | |
| DYDE | Dypsis decaryi ...Triangle Palm | 19 | ea. | 20' tall overall, matched overall and GW heights | |
| *RORE | Roystonea regia ...Royal Palm | 5 | ea. | 25' tall overall, matched overall and GW heights | |
| *SAPA | Sabal palmetto ...Sabal Palm | 26 | ea. | 21 @ 16' tall OA, 1 @ 18' tall oa, 2 @ 20' tall oa, 1 @ 22' tall oa, 1 @ 24' tall oa, smooth trunk; hurricane cut. | |
| VEMO2x | Veitchia montgomeryana ...Montgomery Palm | 5 | ea. | 16' tall OA; double trunks, both heads same height | |
| SHRUBS | | | | | |
| *GACY | Capparis cynophallophora ...Jamaican Caper | 28 | ea. | 24" x 24", 30' o.c. | |
| *CHIC | Chrysobalanus icaco ...Coccolum | 320 | ea. | 24" x 24", 24" o.c. | |
| *ERU | Emodea littoralis ...Golden creeper | 640 | ea. | 18" x 18", 24" o.c. | |
| JAVO | Jasminum volubile ...Wax Jasmine | 339 | ea. | 18" x 18", 24" o.c. | |
| PODO | Podocarpus macrophyllus ...Podocarpus | 90 | ea. | 18" x 18", 24" o.c. | |
| GROUND COVER & GRASSES | | | | | |
| LIEG | Liriope muscari "Variegata" ...Variegated Giant Liriope | 1926 | ea. | 1 gallon cans, full | |
| MISC | Microrosorum scolopendria ...Wart Fern | 275 | ea. | 1 gallon cans, full | |
| *MUCA | Muhlenbergia capillaris ...Muhly Grass | 132 | ea. | 3 gallon cans, full | |
| *TRDA | Tripsacum dalyoides ...Fakahatchee Grass | 161 | ea. | 3 gallon cans, full | |
| OTHER | | | | | |
| sod | St. Augustine "Floratum" Planting Soil 80% Silica Sand Ergalgades Muck Shredded Melaluca Mulch | 20% | as req. as req. | s.f. c.y. | solid sod |
| *Denotes Native Species | | | | | |

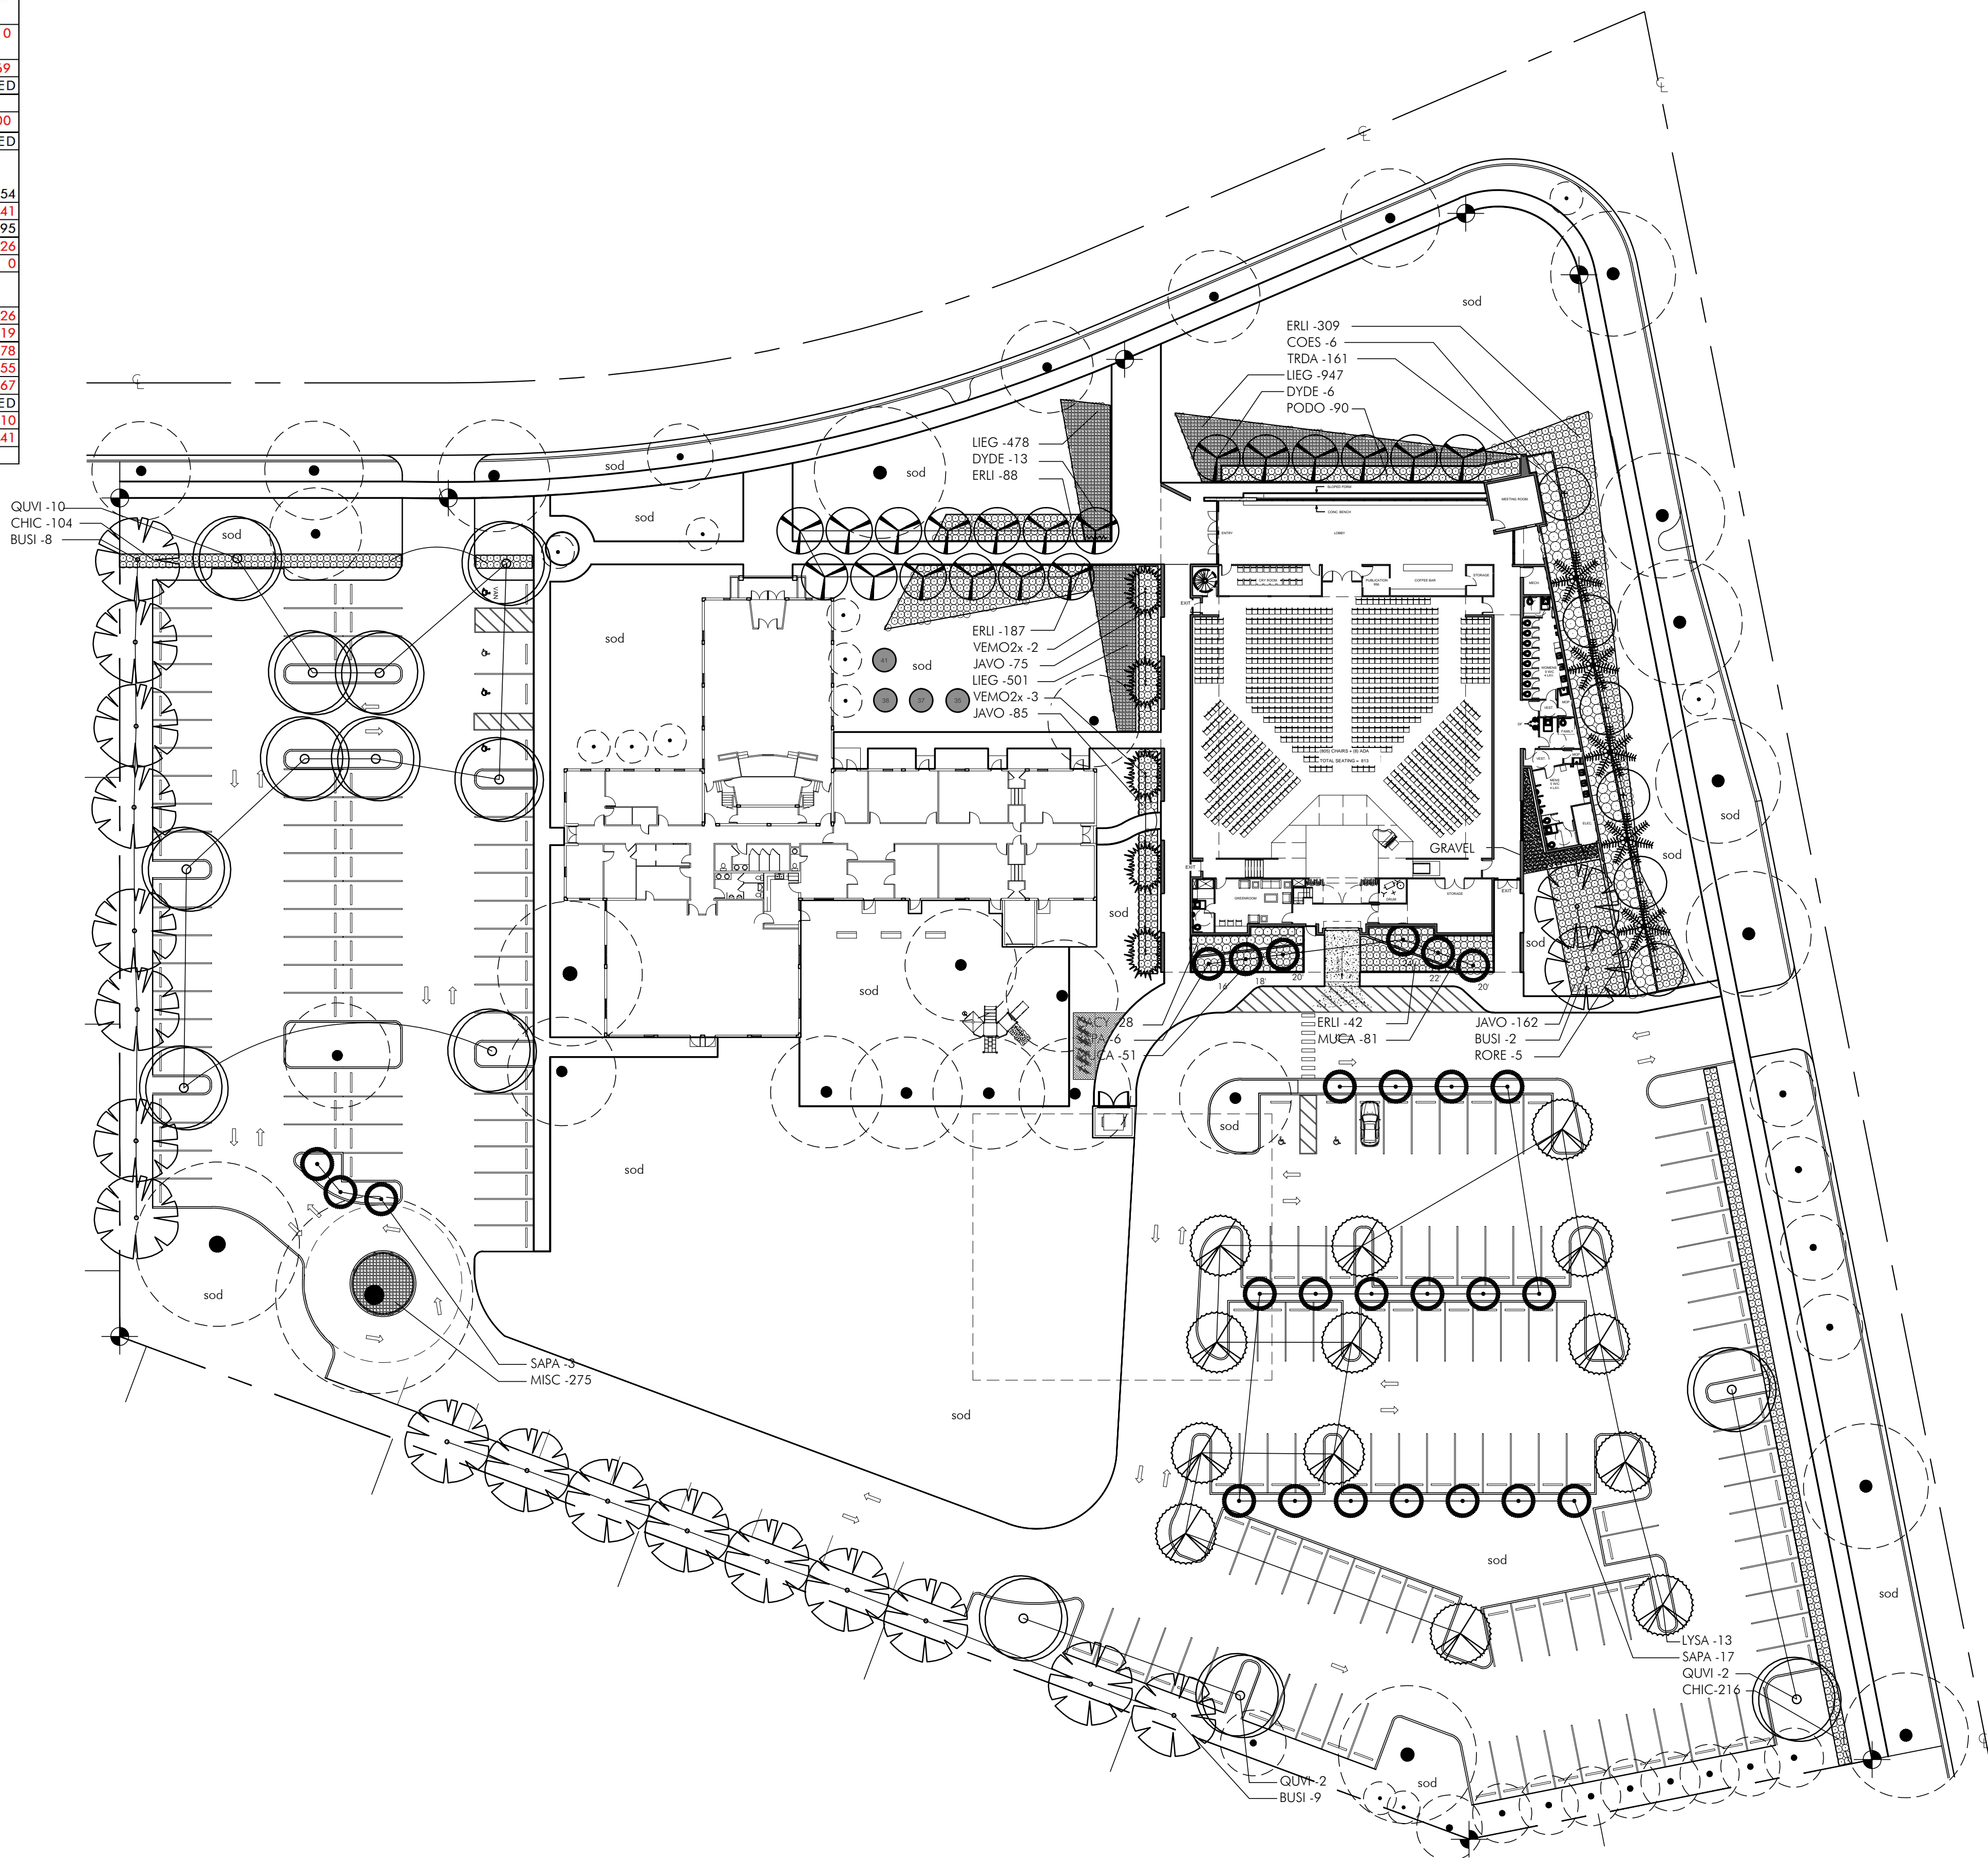

PLANTING PLAN

SCALE: 1"=30'-0"



GARDNER & SEMLER
LANDSCAPE ARCHITECTURE
WWW.GSLADESIGN.COM

17670 NW 78th AVE., SUITE 214
MIA MI, FL 33015
P 305.392.1016 F 305.392.1019
CORP. ID# 0000266

This drawing is the property of GS&L Design and is not to be reproduced or copied in whole or part without written permission. It is not to be used on any other project and is to be returned on request. Contractor is responsible for verifying all site conditions prior to proceeding with work.

C O P Y R I G H T © 2 0 1 7

ELEVATE CHURCH
6215 Miami Lakes Drive
Miami Lakes, FL 33014

[illegible]

TITLE

PLANTING PLAN

| | |
|-----------------------------|-------------------------------|
| Ken Gardner Kiehl Semler | FL LA #1569 FL LA #6667205 |
| DATE | 03.14.17 |
| SCALE | as noted |
| SHEET | LA-3 |

